

	-	q	q
ΓAREA (SQ.FT)	35,000	23063.06*	23063.06*
EET)	150	128.28*	128.28*
CK (FEET)	50	60.70	60.70
(FEET)	50	50.00	50.00
(FEET)	25	36.10	36.10
TBACK (FEET)	60	72.40	72.40
ET)	20	20.00	9.5**
((FEET)	50	66.50	66.50
EET)	20	58.77	58.77
AGE (FEET)	100(50%)	66.98	66.98
IGHT (FEET)	2 STORIES	2 STORIES	2 STORIES
T COVERAGE MAX. (%)	30	21.19	26.23
ATIO (FAR)	0.20	0.20	0.22**

	DESCRIPTION	AREA (SF)
А	GROSS LOT AREA	46,072.33
	EXISTING BUILDING AREA	2,451.07
	SHADE TREE EASEMENT	349.30
в	DRAINAGE EASEMENT	1,150.01
Б	100-YR FLOOD AREA	16,927.41
	75% OF AREA WITH SLOPES BETWEEN 15-20%	3,232.66
		1 000 20


IMPERVIOUS AREA	AREA (SF)
EXISTING DWELLING	2,451.07
ASPHALT DRIVEWAY	2,027.56
CONCRETE WALKWAY	183.65
CONCRETE PAD	77.25
HOT TUB	63.81
SHED	82.93
TOTAL	4,886.27


PROPOSED COVERAGE

IMPERVIOUS AREA	AREA (SF)
EXISTING DWELLING	2,451.07
PROPOSED MIKVAH	374.00
ASPHALT DRIVEWAY	2,815.76
CONCRETE WALKWAY	183.65
CONCRETE PAD	77.25
HOT TUB	63.81
SHED	82.93
TOTAL	6.048.47

DATE	
	DWNER
17. PLANS ARE BASED ON FIELD ENGINEERING DATA AND CERTIFIED HERETO BY:	




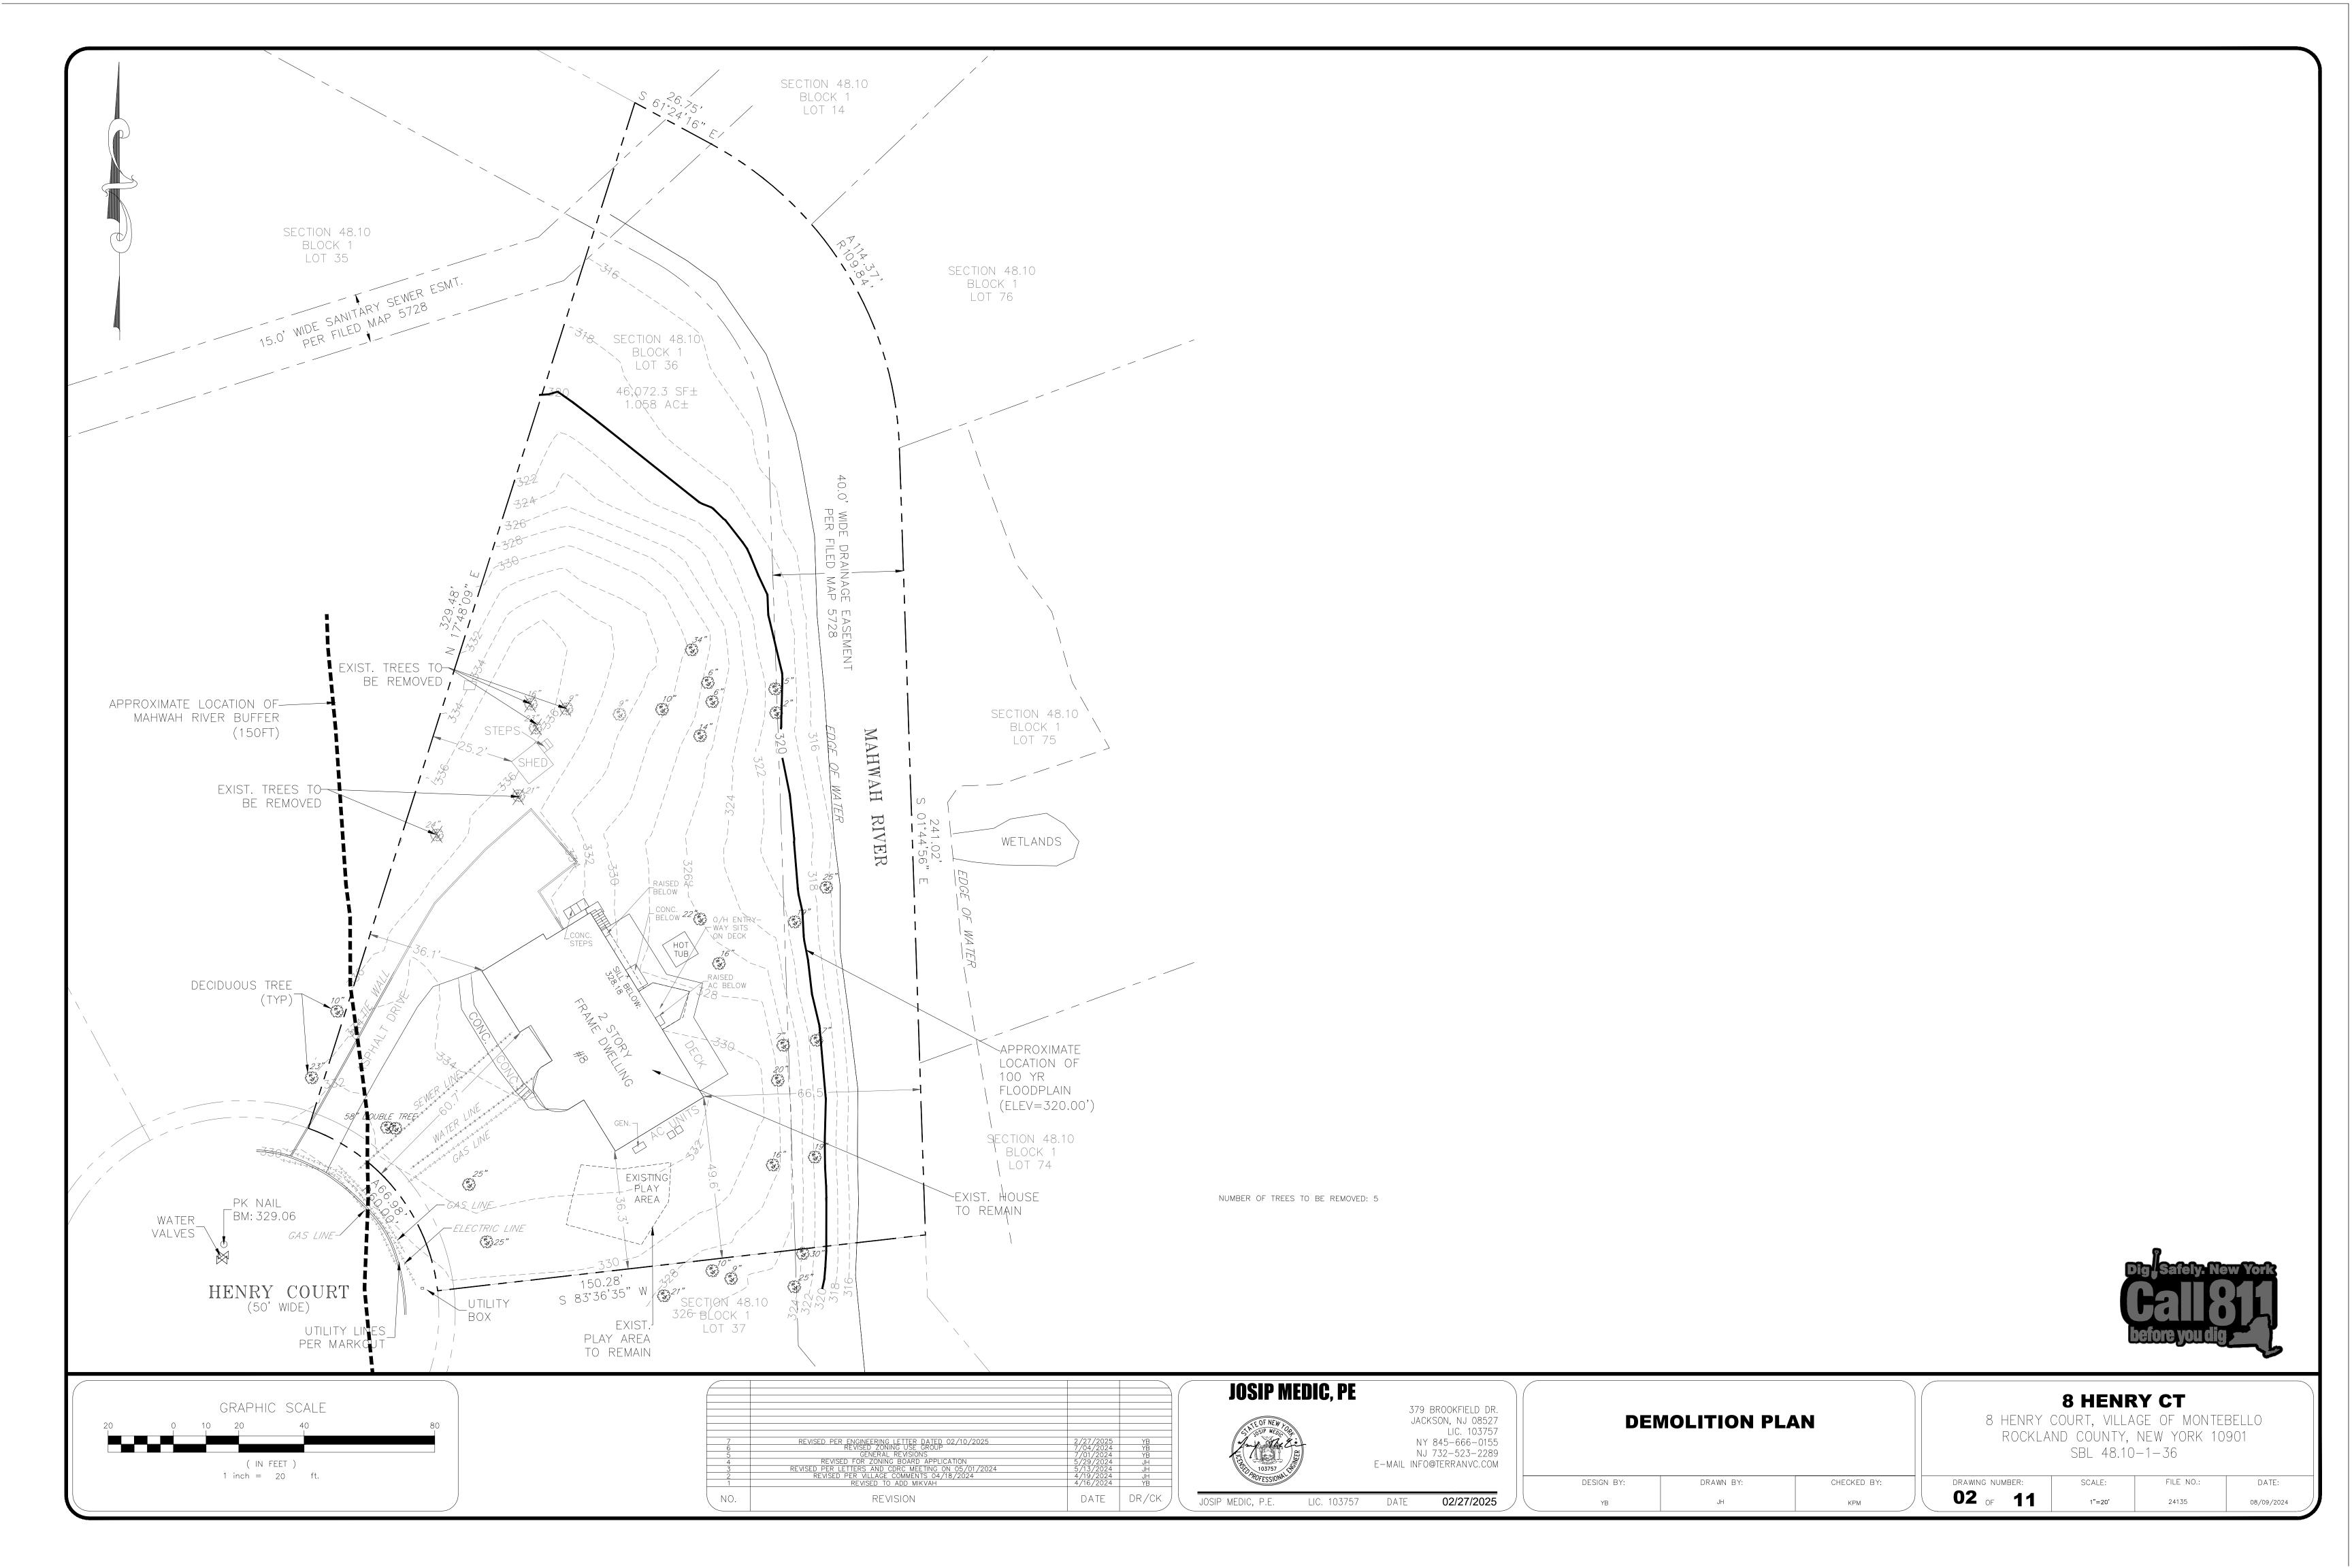


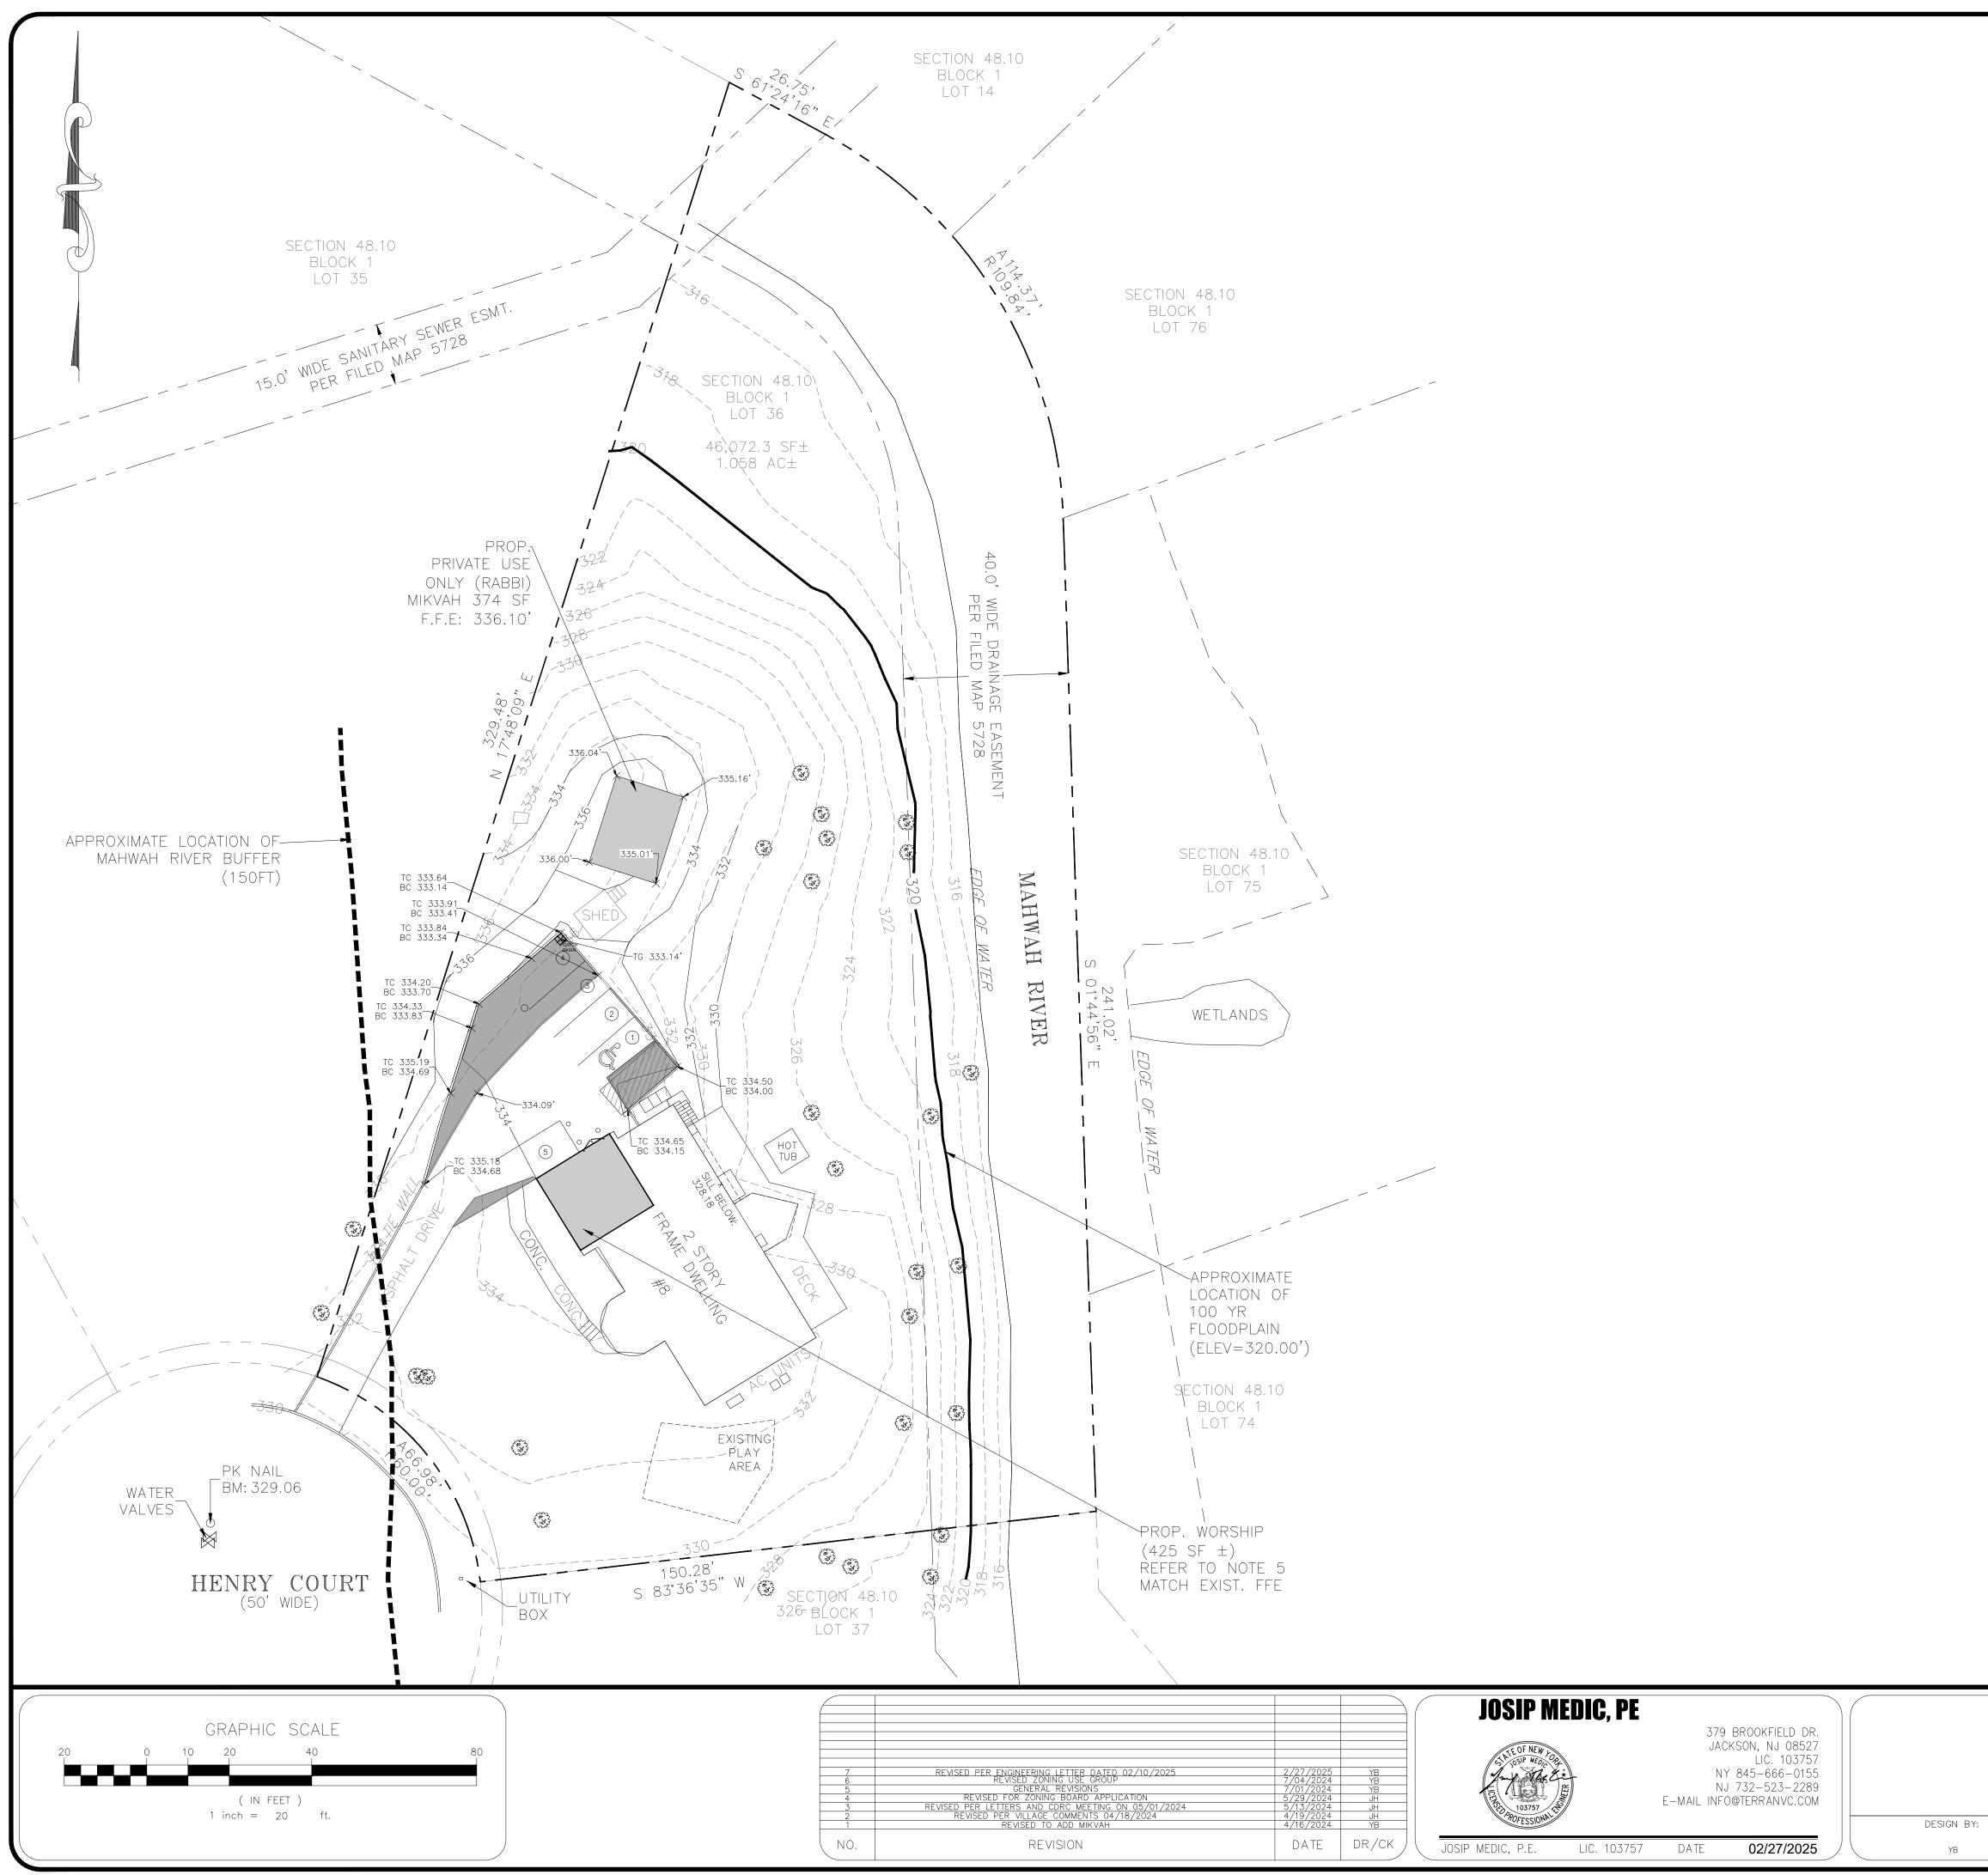



8 HENRY CT GRADING PLAN 8 HENRY COURT, VILLAGE OF MONTEBELLO ROCKLAND COUNTY, NEW YORK 10901 SBL 48.10-1-36 DRAWING NUMBER: FILE NO.: CHECKED BY: SCALE: DATE: DRAWN BY: **03** OF **11** 1"=20' 24135 KPM 08/09/2024 JH

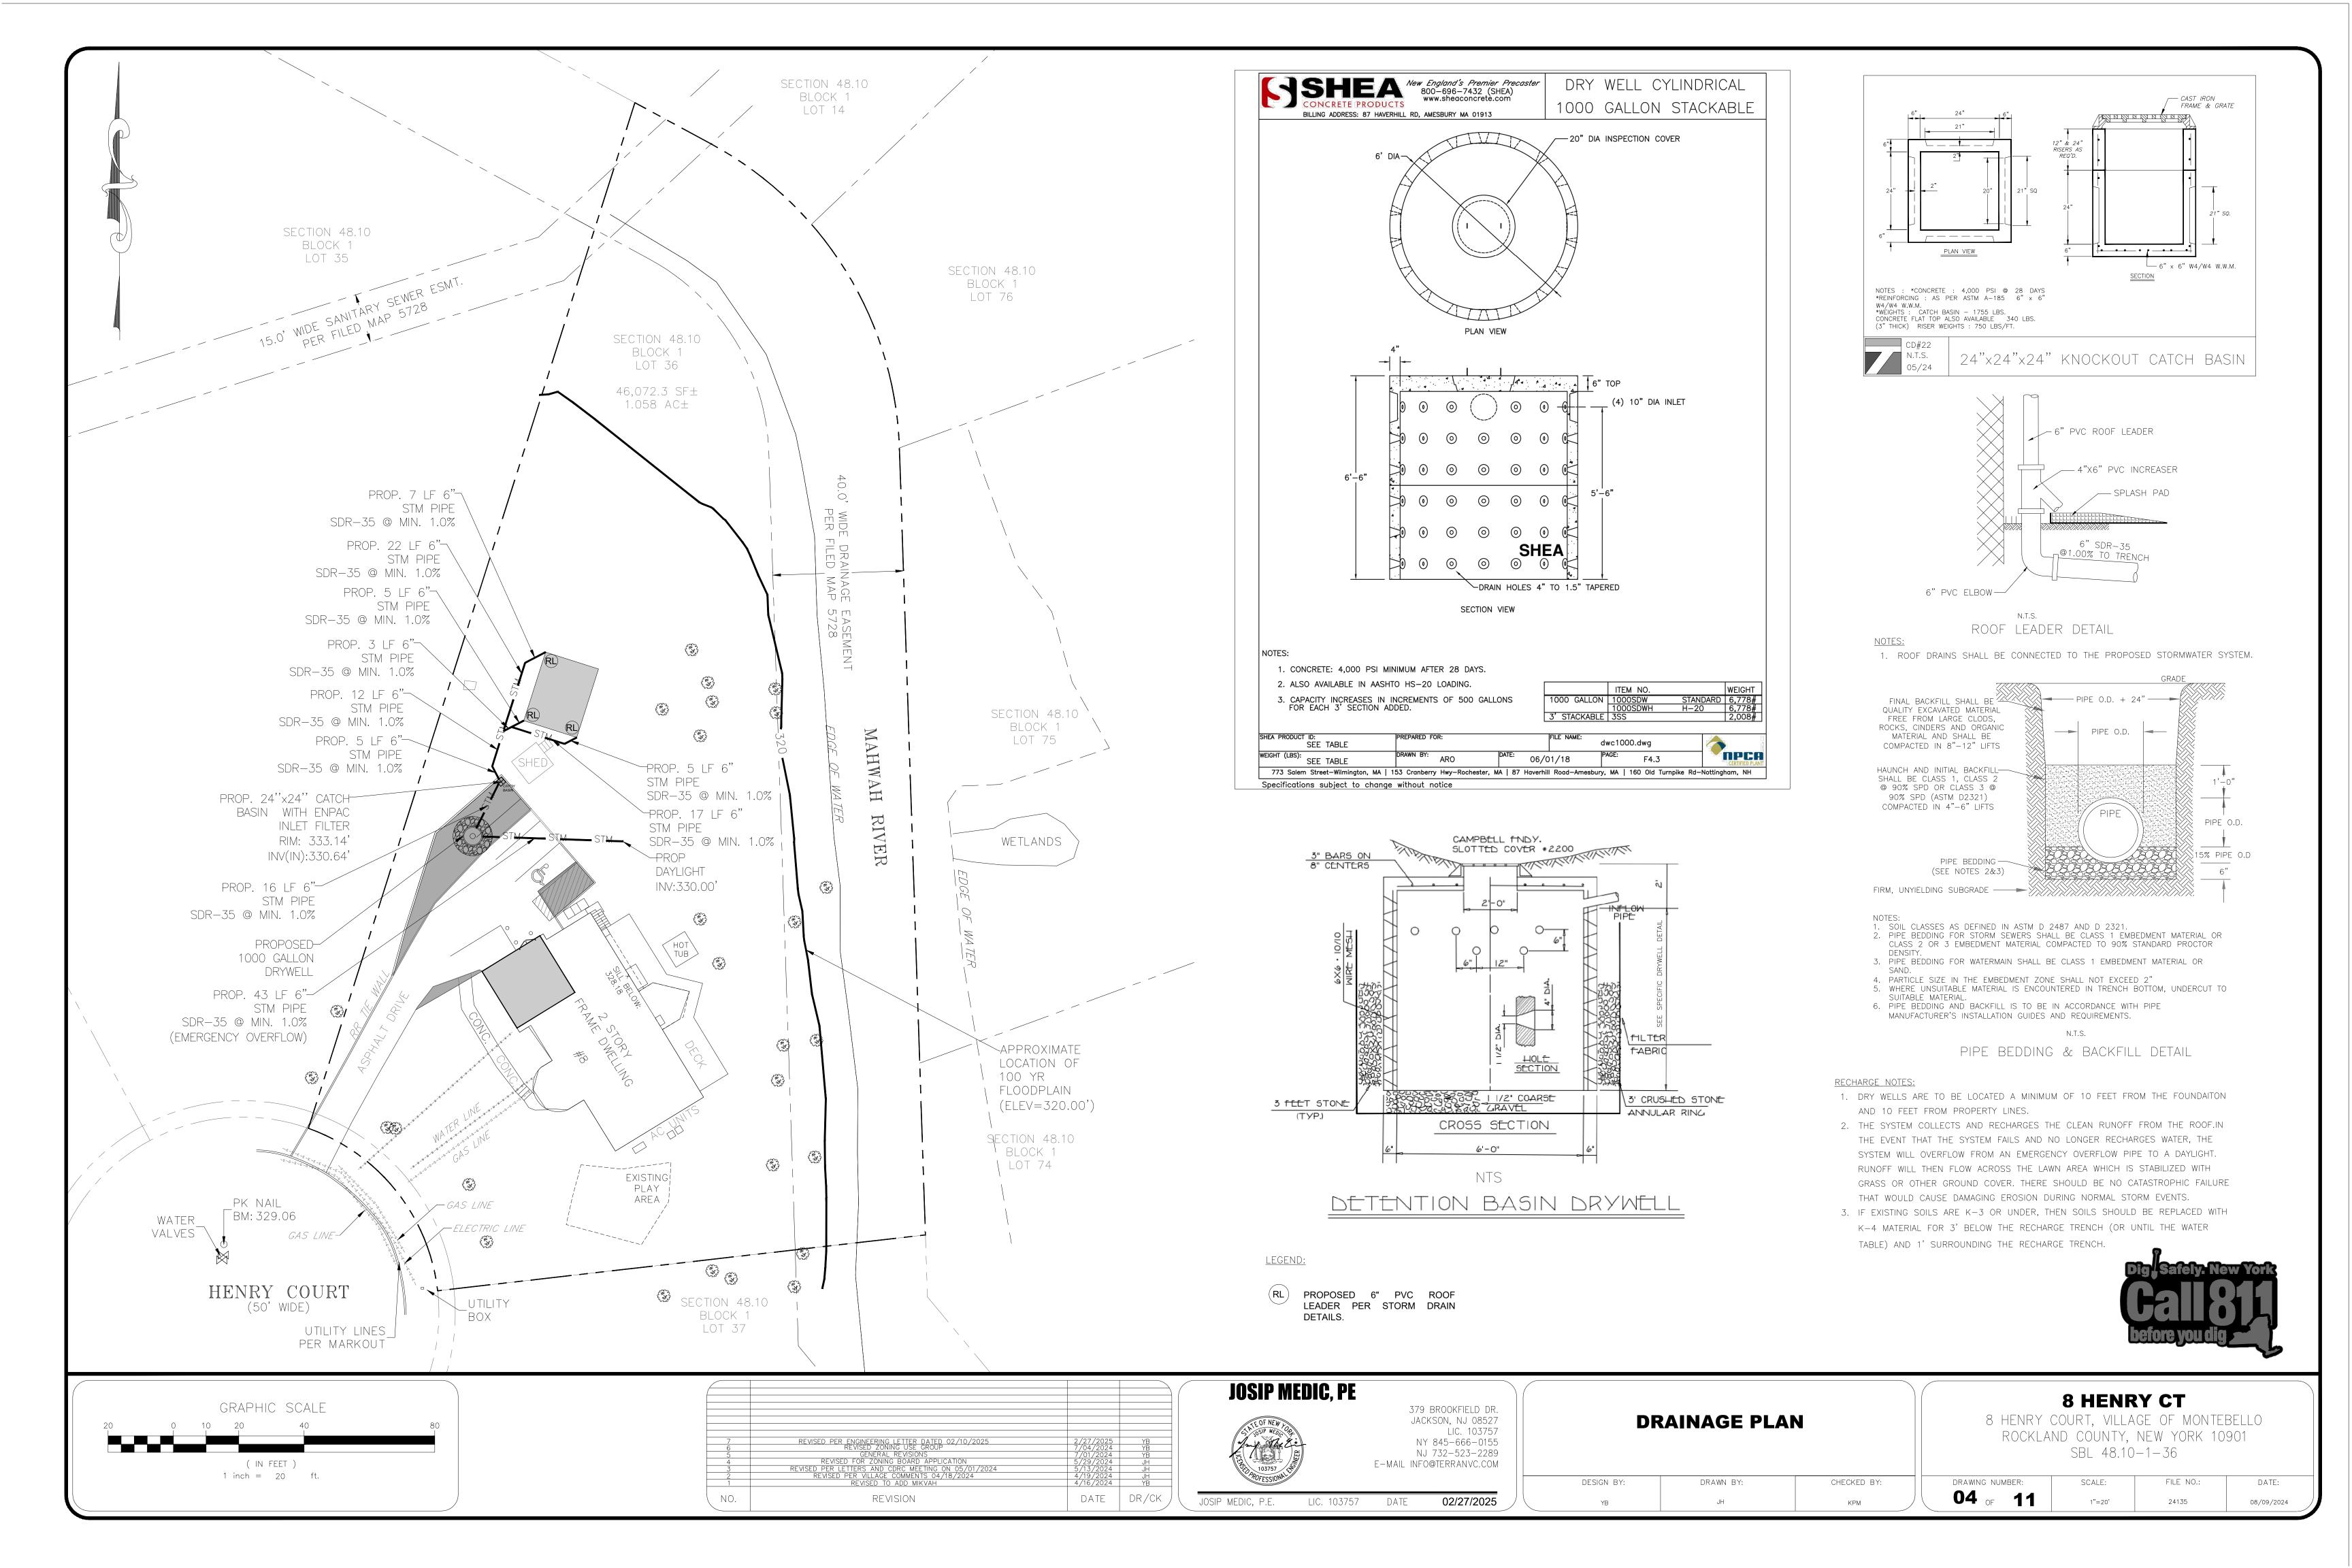

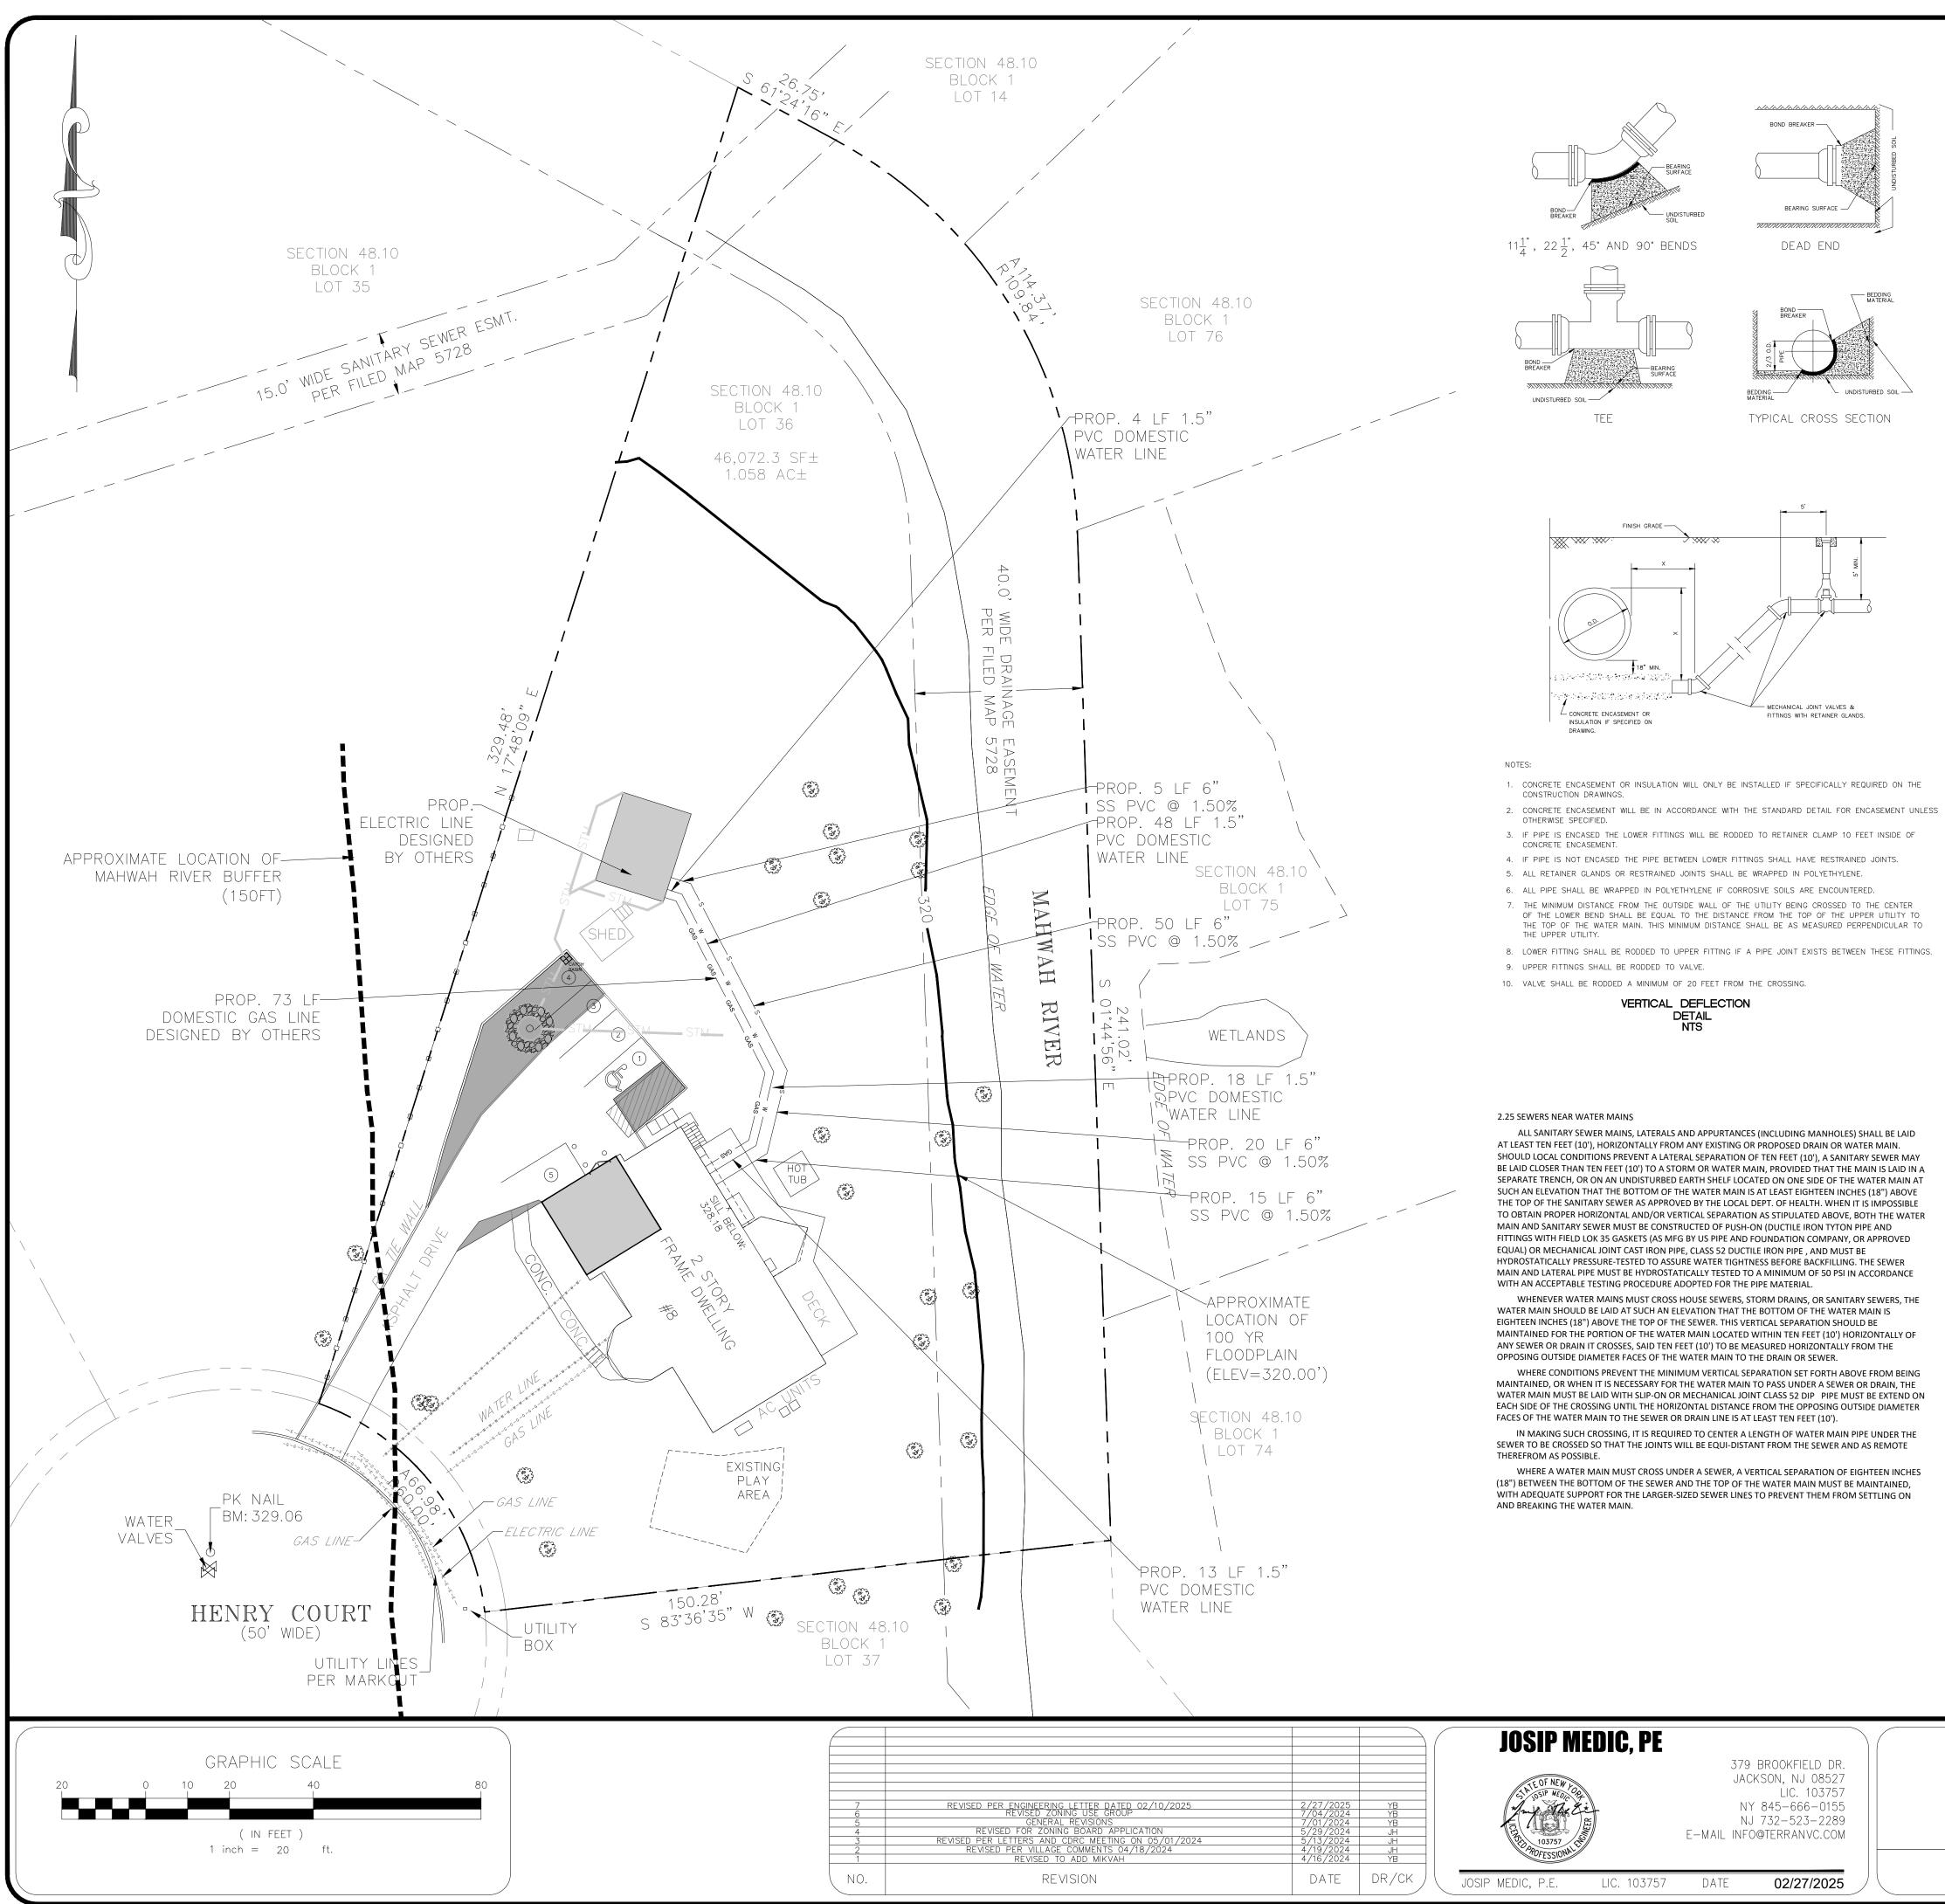

E-MAIL INFO@TERRANVC.COM

379 BROOKFIELD DR. JACKSON, NJ 08527 LIC. 103757 NY 845-666-0155 NJ 732-523-2289

02/27/2025

DESIGN BY: YΒ

DRAWN BY:

JH

WATER MAIN MUST BE LAID WITH SLIP-ON OR MECHANICAL JOINT CLASS 52 DIP PIPE MUST BE EXTEND ON EACH SIDE OF THE CROSSING UNTIL THE HORIZONTAL DISTANCE FROM THE OPPOSING OUTSIDE DIAMETER FACES OF THE WATER MAIN TO THE SEWER OR DRAIN LINE IS AT LEAST TEN FEET (10'). IN MAKING SUCH CROSSING, IT IS REQUIRED TO CENTER A LENGTH OF WATER MAIN PIPE UNDER THE SEWER TO BE CROSSED SO THAT THE JOINTS WILL BE EQUI-DISTANT FROM THE SEWER AND AS REMOTE WHERE A WATER MAIN MUST CROSS UNDER A SEWER, A VERTICAL SEPARATION OF EIGHTEEN INCHES (18") BETWEEN THE BOTTOM OF THE SEWER AND THE TOP OF THE WATER MAIN MUST BE MAINTAINED,

WHENEVER WATER MAINS MUST CROSS HOUSE SEWERS, STORM DRAINS, OR SANITARY SEWERS, THE WATER MAIN SHOULD BE LAID AT SUCH AN ELEVATION THAT THE BOTTOM OF THE WATER MAIN IS EIGHTEEN INCHES (18") ABOVE THE TOP OF THE SEWER. THIS VERTICAL SEPARATION SHOULD BE MAINTAINED FOR THE PORTION OF THE WATER MAIN LOCATED WITHIN TEN FEET (10') HORIZONTALLY OF ANY SEWER OR DRAIN IT CROSSES, SAID TEN FEET (10') TO BE MEASURED HORIZONTALLY FROM THE OPPOSING OUTSIDE DIAMETER FACES OF THE WATER MAIN TO THE DRAIN OR SEWER. WHERE CONDITIONS PREVENT THE MINIMUM VERTICAL SEPARATION SET FORTH ABOVE FROM BEING


SUCH AN ELEVATION THAT THE BOTTOM OF THE WATER MAIN IS AT LEAST EIGHTEEN INCHES (18") ABOVE THE TOP OF THE SANITARY SEWER AS APPROVED BY THE LOCAL DEPT. OF HEALTH. WHEN IT IS IMPOSSIBLE TO OBTAIN PROPER HORIZONTAL AND/OR VERTICAL SEPARATION AS STIPULATED ABOVE, BOTH THE WATER MAIN AND SANITARY SEWER MUST BE CONSTRUCTED OF PUSH-ON (DUCTILE IRON TYTON PIPE AND FITTINGS WITH FIELD LOK 35 GASKETS (AS MFG BY US PIPE AND FOUNDATION COMPANY, OR APPROVED EQUAL) OR MECHANICAL JOINT CAST IRON PIPE, CLASS 52 DUCTILE IRON PIPE , AND MUST BE HYDROSTATICALLY PRESSURE-TESTED TO ASSURE WATER TIGHTNESS BEFORE BACKFILLING. THE SEWER MAIN AND LATERAL PIPE MUST BE HYDROSTATICALLY TESTED TO A MINIMUM OF 50 PSI IN ACCORDANCE WITH AN ACCEPTABLE TESTING PROCEDURE ADOPTED FOR THE PIPE MATERIAL.


ALL SANITARY SEWER MAINS, LATERALS AND APPURTANCES (INCLUDING MANHOLES) SHALL BE LAID AT LEAST TEN FEET (10'), HORIZONTALLY FROM ANY EXISTING OR PROPOSED DRAIN OR WATER MAIN. SHOULD LOCAL CONDITIONS PREVENT A LATERAL SEPARATION OF TEN FEET (10'), A SANITARY SEWER MAY BE LAID CLOSER THAN TEN FEET (10') TO A STORM OR WATER MAIN, PROVIDED THAT THE MAIN IS LAID IN A SEPARATE TRENCH, OR ON AN UNDISTURBED EARTH SHELF LOCATED ON ONE SIDE OF THE WATER MAIN AT



8. LOWER FITTING SHALL BE RODDED TO UPPER FITTING IF A PIPE JOINT EXISTS BETWEEN THESE FITTINGS.

- 6. ALL PIPE SHALL BE WRAPPED IN POLYETHYLENE IF CORROSIVE SOILS ARE ENCOUNTERED. 7. THE MINIMUM DISTANCE FROM THE OUTSIDE WALL OF THE UTILITY BEING CROSSED TO THE CENTER OF THE LOWER BEND SHALL BE EQUAL TO THE DISTANCE FROM THE TOP OF THE UPPER UTILITY TO THE TOP OF THE WATER MAIN. THIS MINIMUM DISTANCE SHALL BE AS MEASURED PERPENDICULAR TO
- 3. IF PIPE IS ENCASED THE LOWER FITTINGS WILL BE RODDED TO RETAINER CLAMP 10 FEET INSIDE OF 4. IF PIPE IS NOT ENCASED THE PIPE BETWEEN LOWER FITTINGS SHALL HAVE RESTRAINED JOINTS. 5. ALL RETAINER GLANDS OR RESTRAINED JOINTS SHALL BE WRAPPED IN POLYETHYLENE.
- 1. CONCRETE ENCASEMENT OR INSULATION WILL ONLY BE INSTALLED IF SPECIFICALLY REQUIRED ON THE

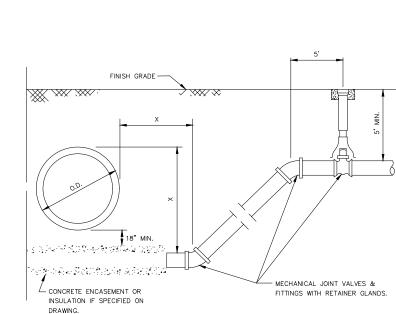

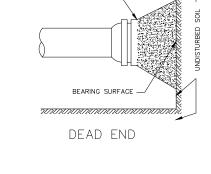


TYPICAL CROSS SECTION

BEDDING MATERIAL

BOND BREAKER -

BEDDING – MATERIAL

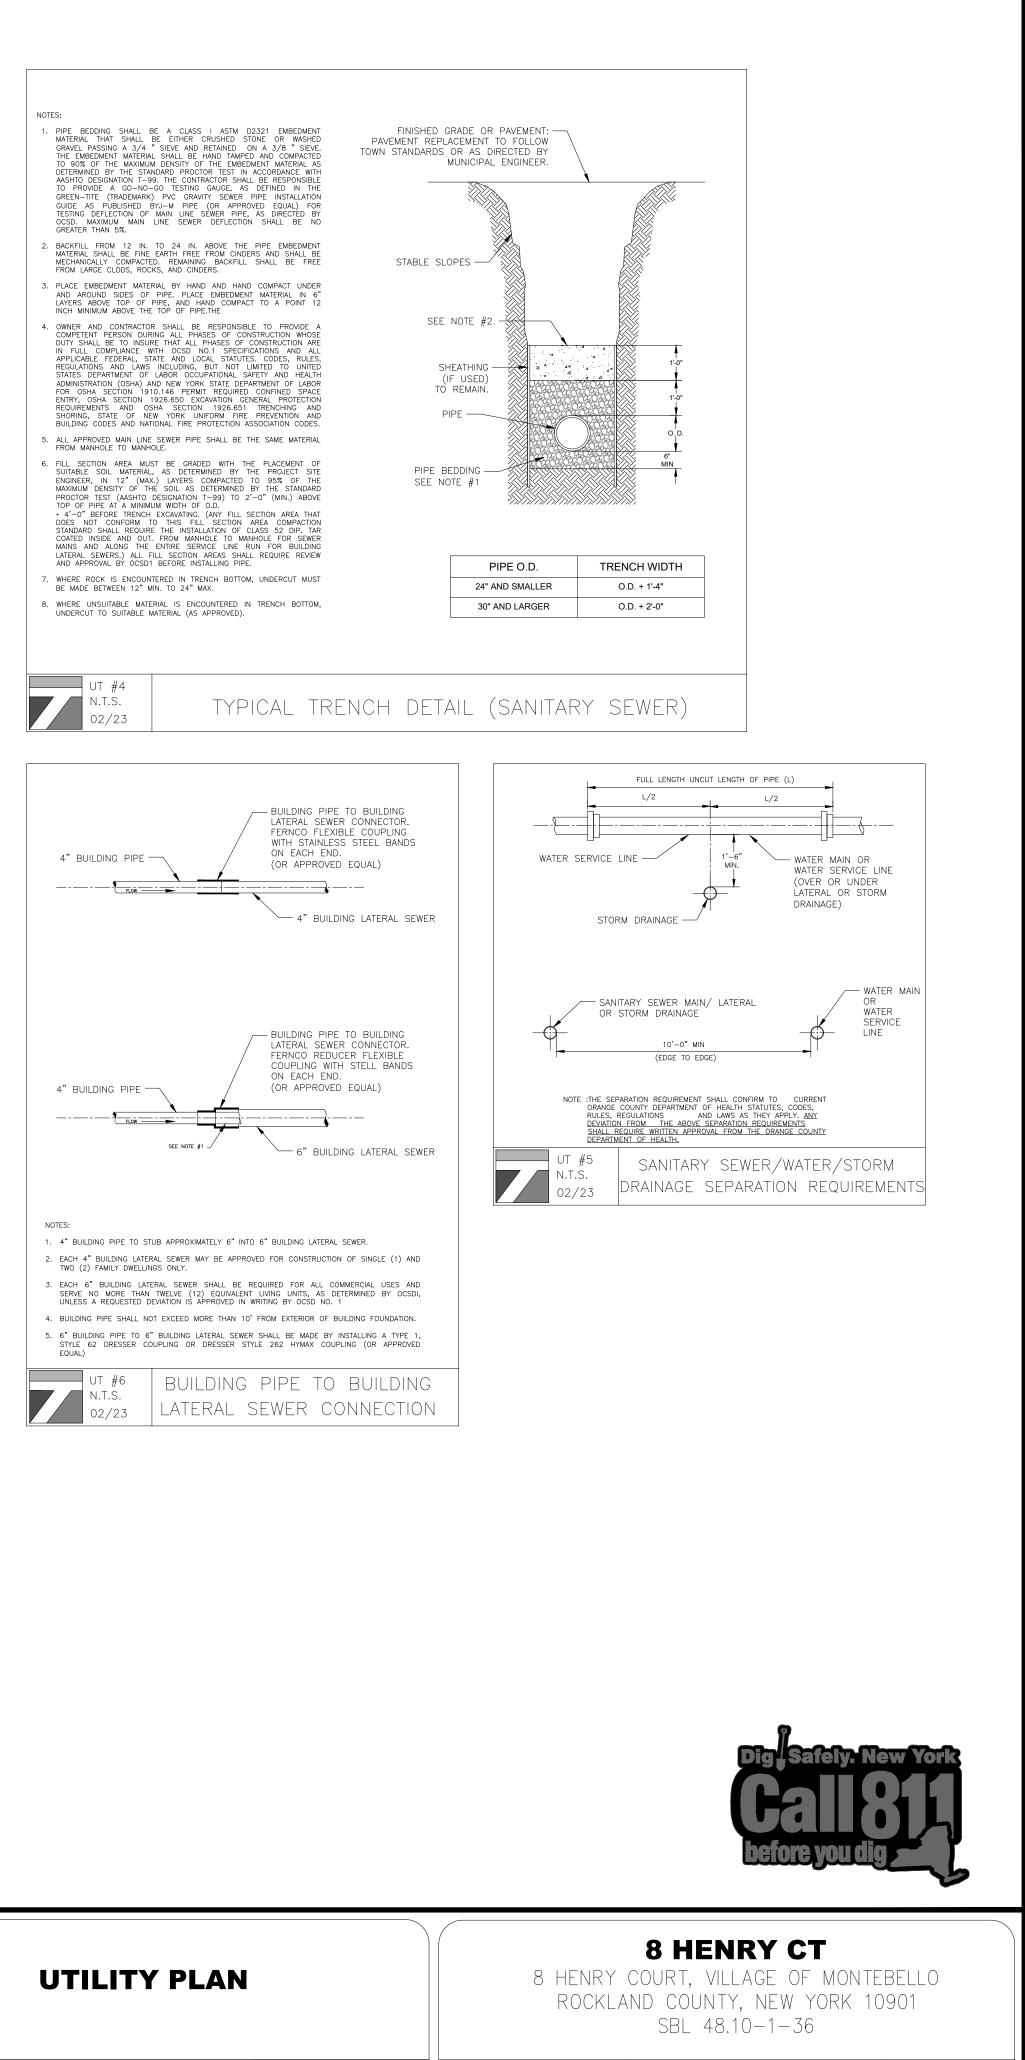

DRAWING NUMBER:

05 OF **11**

CHECKED BY:

KPM

SCALE:


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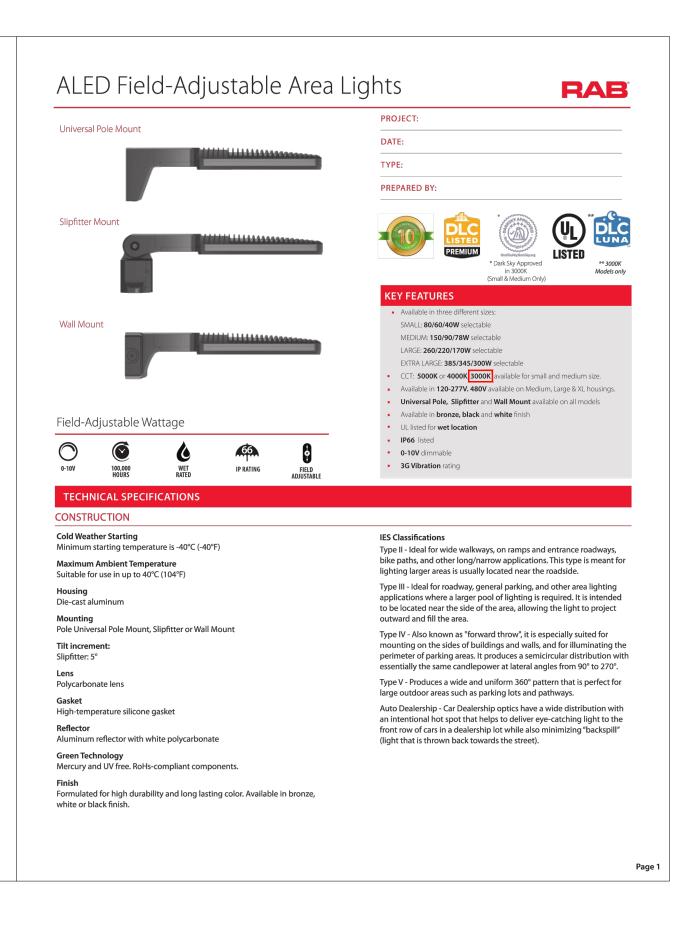
08/09/2024


FILE NO.:

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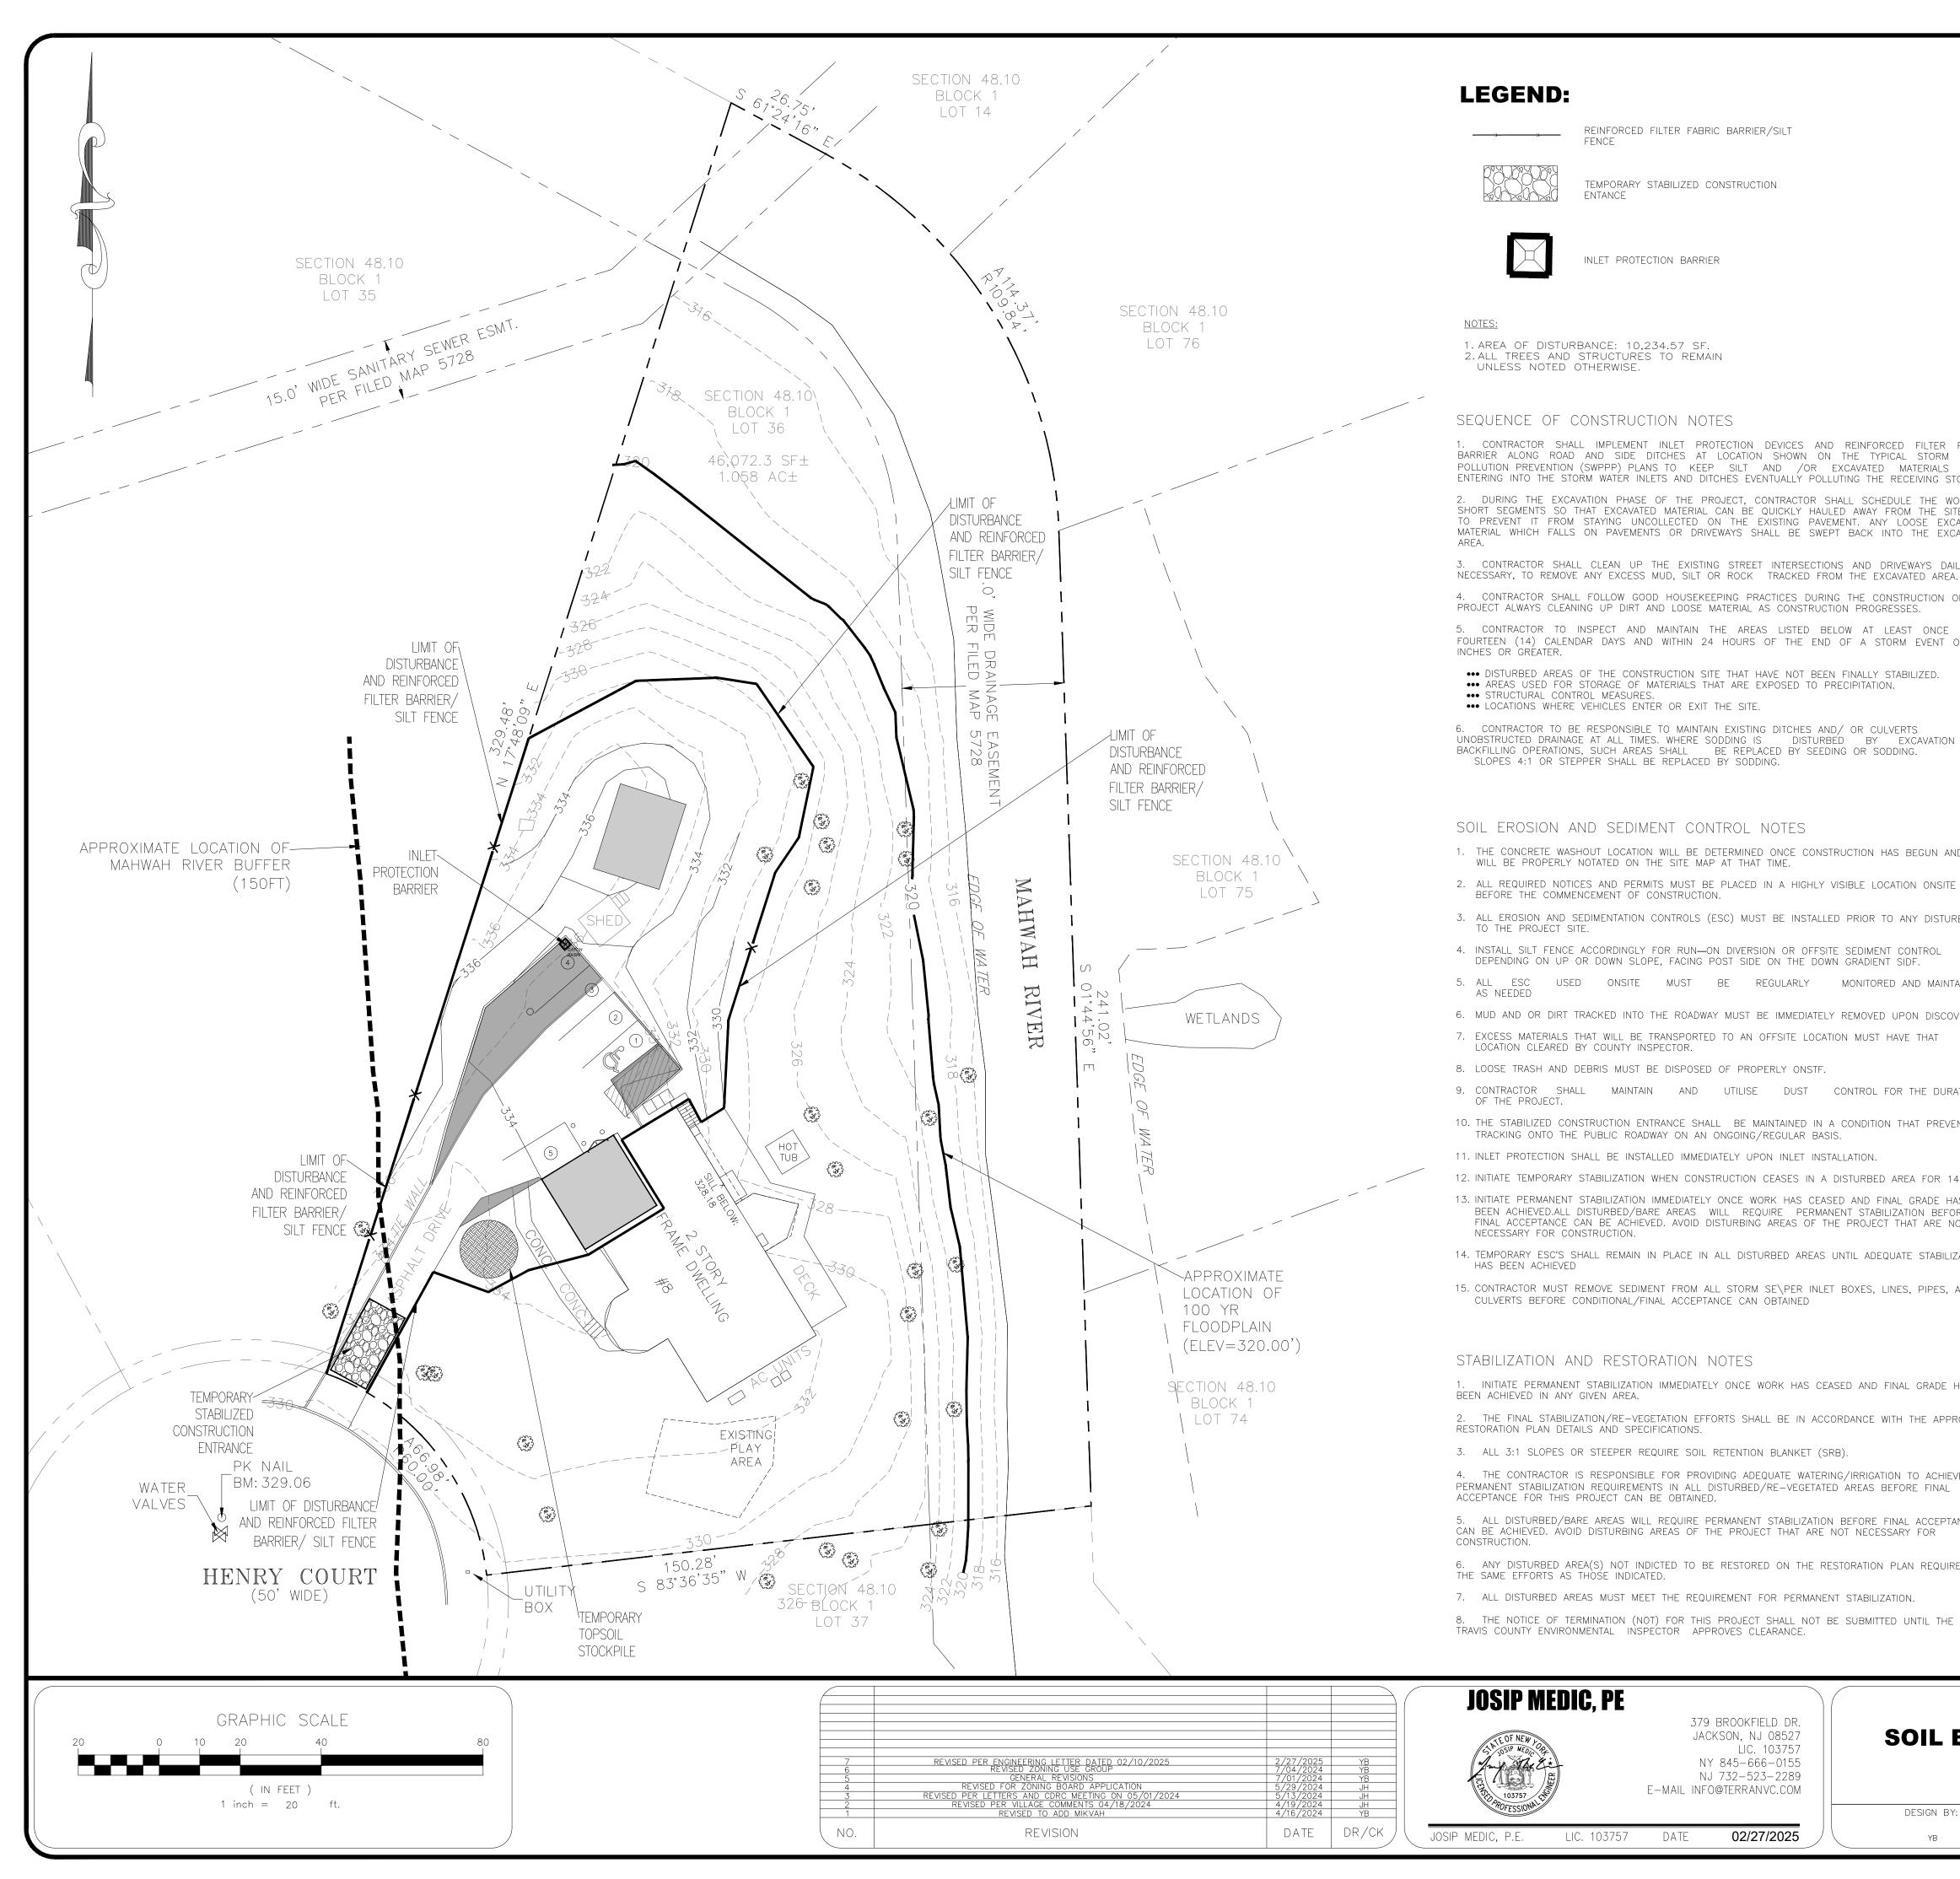
			JOSIP MEDIC, PE			
E ENGINEERING LETTER DATED 02/10/2025 REVISED ZONING USE GROUP GENERAL REVISIONS ED FOR ZONING BOARD APPLICATION ETTERS AND CDRC MEETING ON 05/01/2024 PER VILLAGE COMMENTS 04/18/2024	2/27/2025 7/04/2024 7/01/2024 5/29/2024 5/13/2024 4/19/2024	YB YB JH JH	Sth TE OF NEW LOOP Sth TO SIP MEDO OP THE THE THE THE THE THE THE THE THE THE	379 BROOKFIELD JACKSON, NJ 085 LIC. 1037 NY 845-666-0 NJ 732-523-22 E-MAIL INFO@TERRANVC.C	527 757 155 289	L
REVISED TO ADD MIKVAH	4/16/2024	JH YB	TOFESSIONAL			DESIGN BY:
REVISION	DATE	DR/CK	JOSIP MEDIC, P.E. LIC. 103757	DATE 02/27/20	25	YB





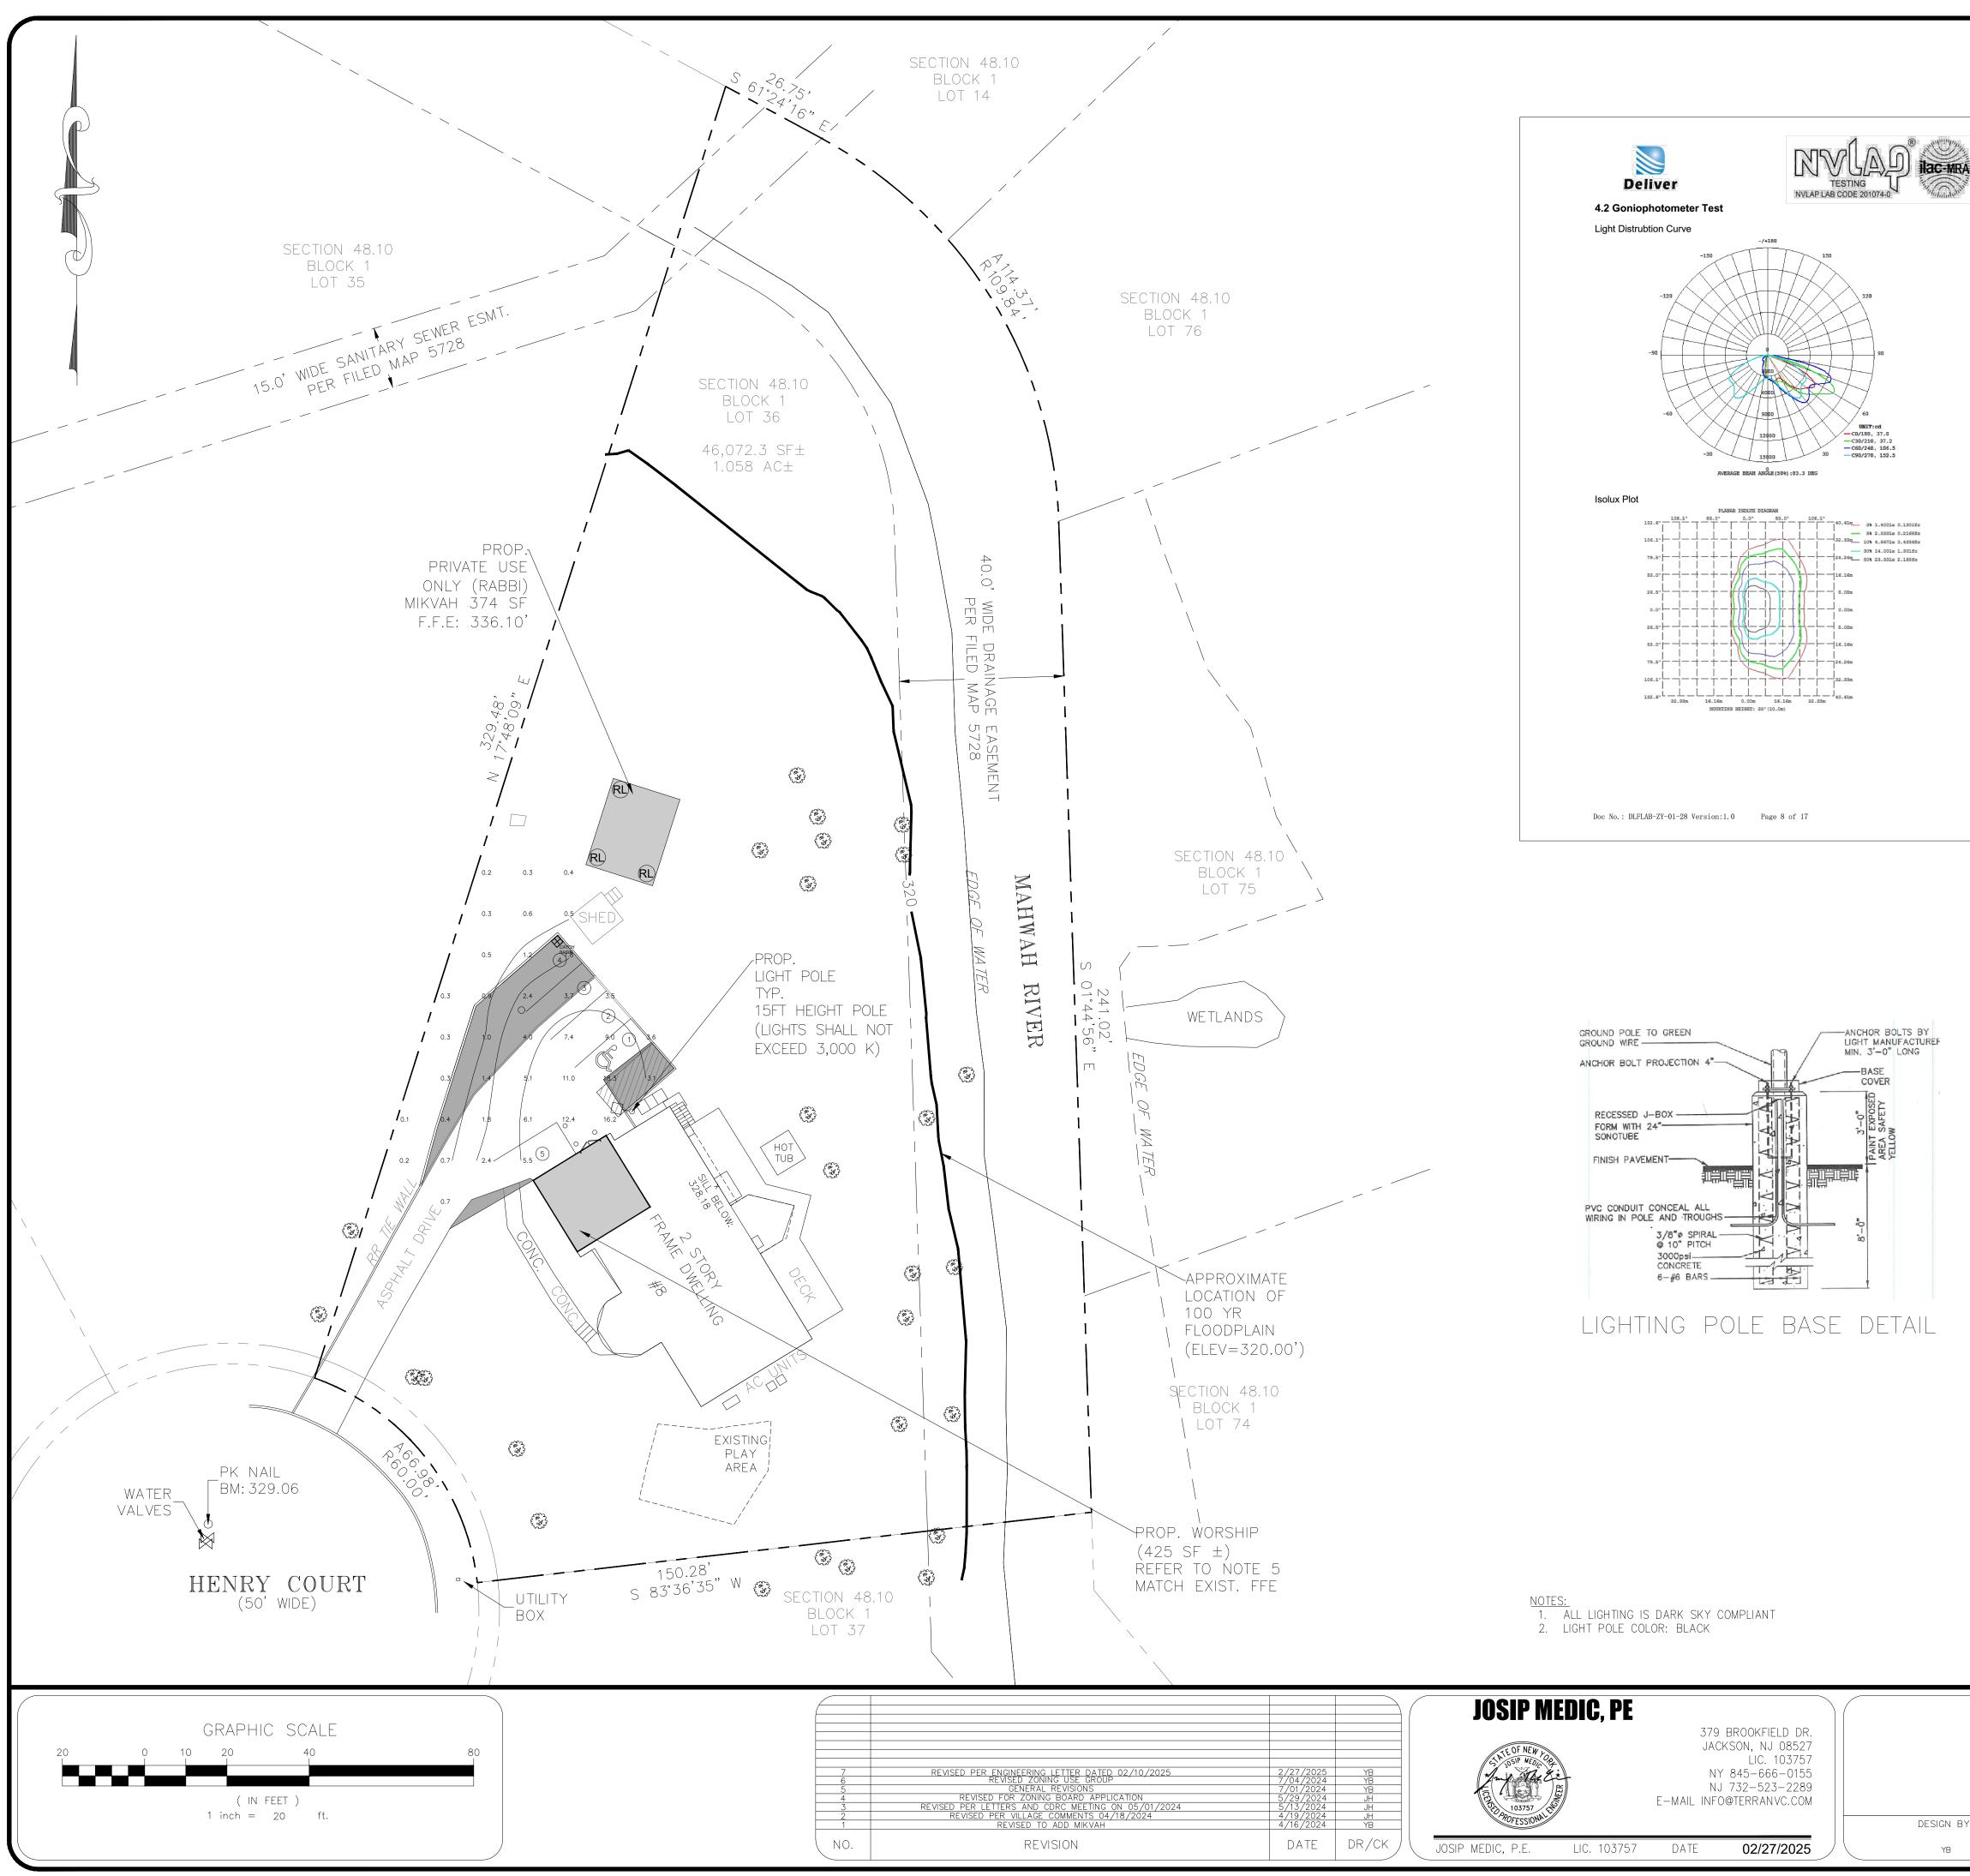

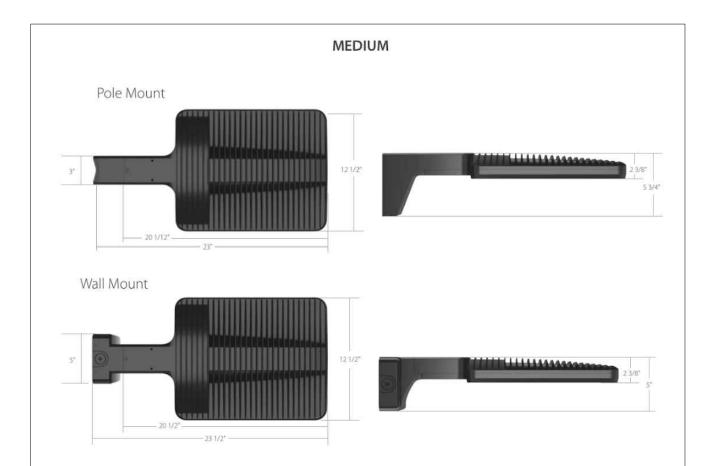8 HENRY CT LIGHTING PLAN 8 HENRY COURT, VILLAGE OF MONTEBELLO ROCKLAND COUNTY, NEW YORK 10901 SBL 48.10-1-36 DRAWING NUMBER: CHECKED BY: SCALE: FILE NO.: DATE: DRAWN BY: **06** OF **11** 1"=20' 24135 08/09/2024 KPM JH



LEGEND:

REINFORCED FILTER FABRIC BARRIER/SILT FENCE

TEMPORARY STABILIZED CONSTRUCTION

ENTANCE



••• DISTURBED AREAS OF THE CONSTRUCTION SITE THAT HAVE NOT BEEN FINALLY STABILIZED.

DEPENDING ON UP OR DOWN SLOPE, FACING POST SIDE ON THE DOWN GRADIENT SIDF.

TRACKING ONTO THE PUBLIC ROADWAY ON AN ONGOING/REGULAR BASIS.

CULVERTS BEFORE CONDITIONAL/FINAL ACCEPTANCE CAN OBTAINED

SLOPES 4:1 OR STEPPER SHALL BE REPLACED BY SODDING.

WILL BE PROPERLY NOTATED ON THE SITE MAP AT THAT TIME.

BEFORE THE COMMENCEMENT OF CONSTRUCTION.

LOCATION CLEARED BY COUNTY INSPECTOR.

TO THE PROJECT SITE.

AS NEEDED

OF THE PROJECT.

NECESSARY FOR CONSTRUCTION.

JOSIP MEDIC, PE

LIC. 103757

HAS BEEN ACHIEVED

INLET PROTECTION BARRIER



UNLESS NOTED OTHERWISE.

<u>NOTES:</u>

379 BROOKFIELD DR.

JACKSON, NJ 08527

NY 845-666-0155

NJ 732-523-2289

E-MAIL INFO@TERRANVC.COM


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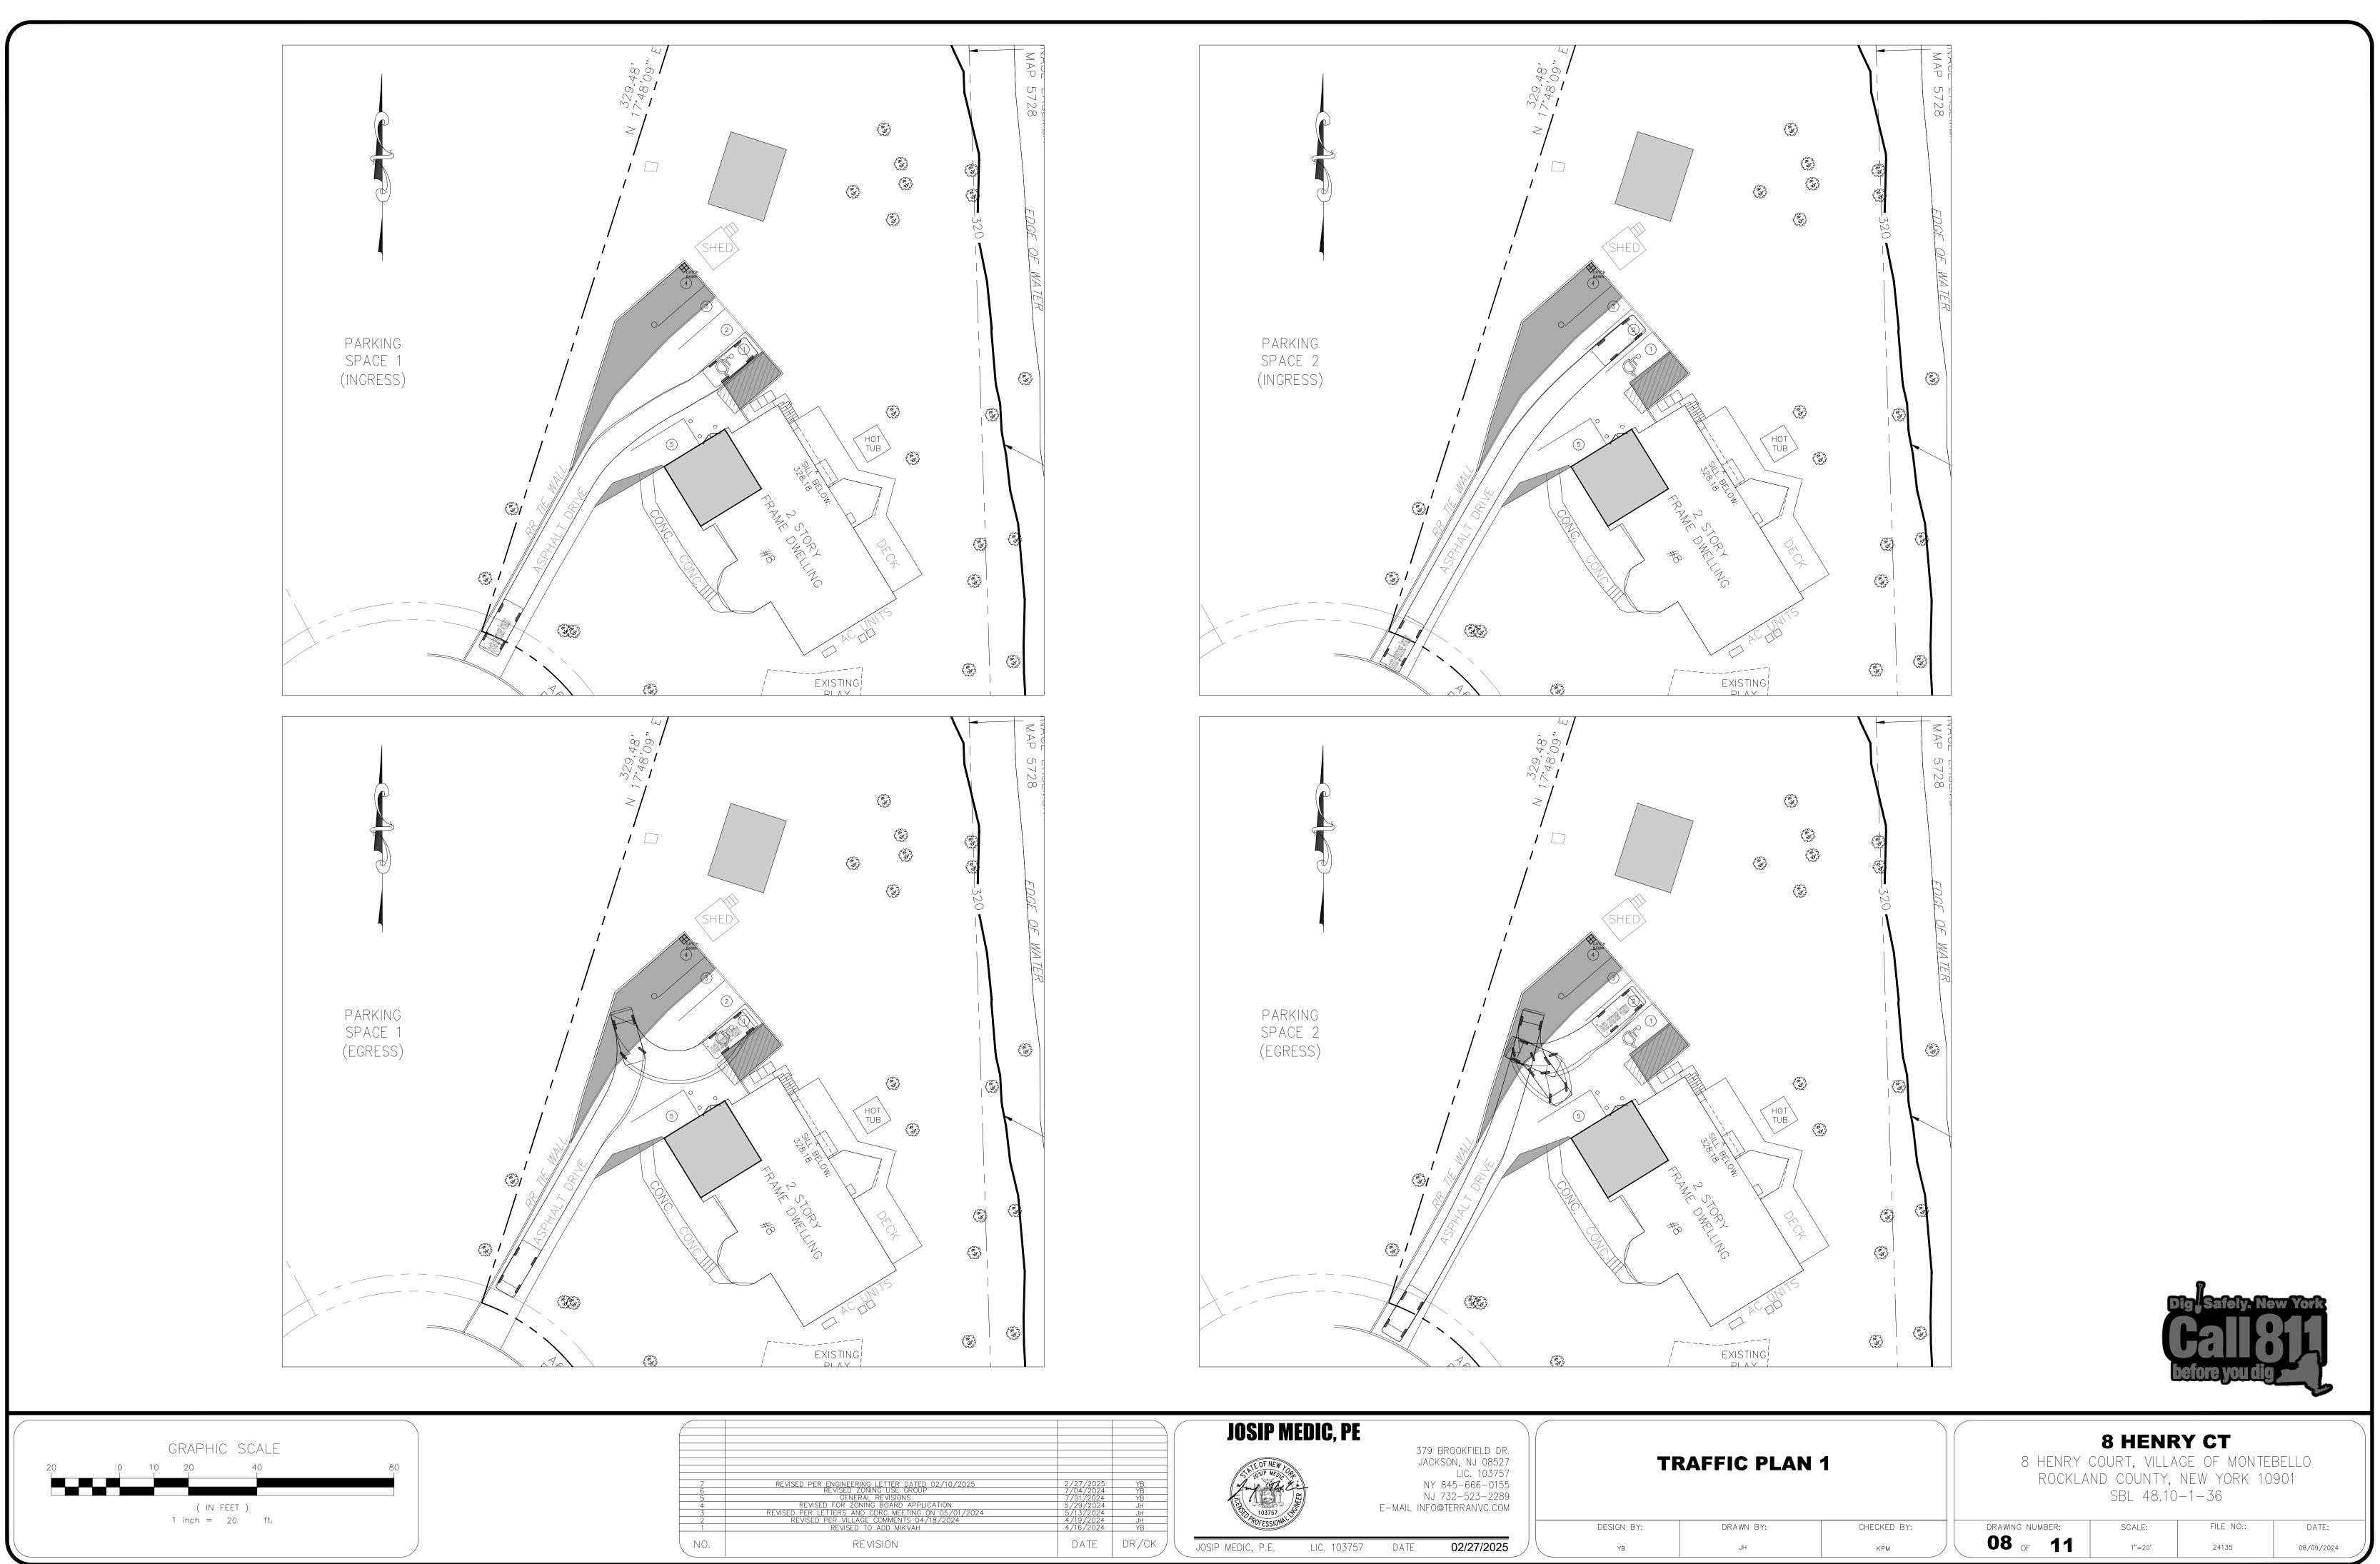
LIC. 103757

02/27/2025


DESIGN BY:

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			JOSIP MEDIC, PE			
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REVISION	DATE	DR/CK	JOSIP MEDIC, P.E. LIC. 103757	DATE	02/27/2025	YB
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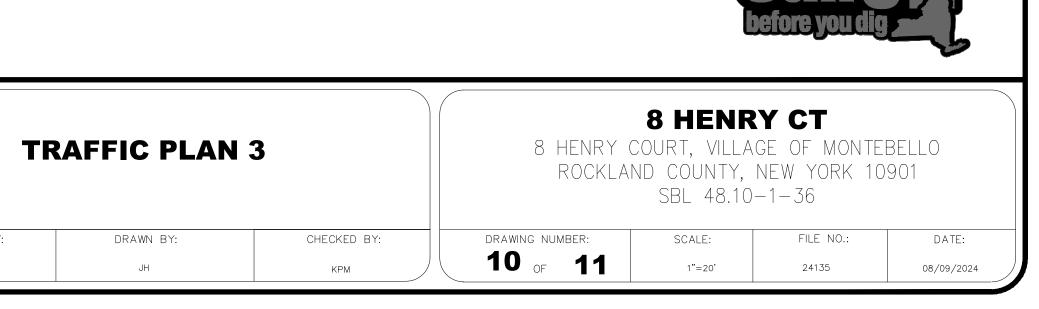



			JOSIP MEDIC, PE			
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REVISED PER VILLAGE COMMENTS 04/18/2024 REVISED TO ADD MIKVAH	4/19/2024 4/16/2024	JH YB	TOFESSIONAL			DESIGN BY:
REVISION	DATE	DR/CK	JOSIP MEDIC, P.E. LIC. 103757	DATE	02/27/2025	YB

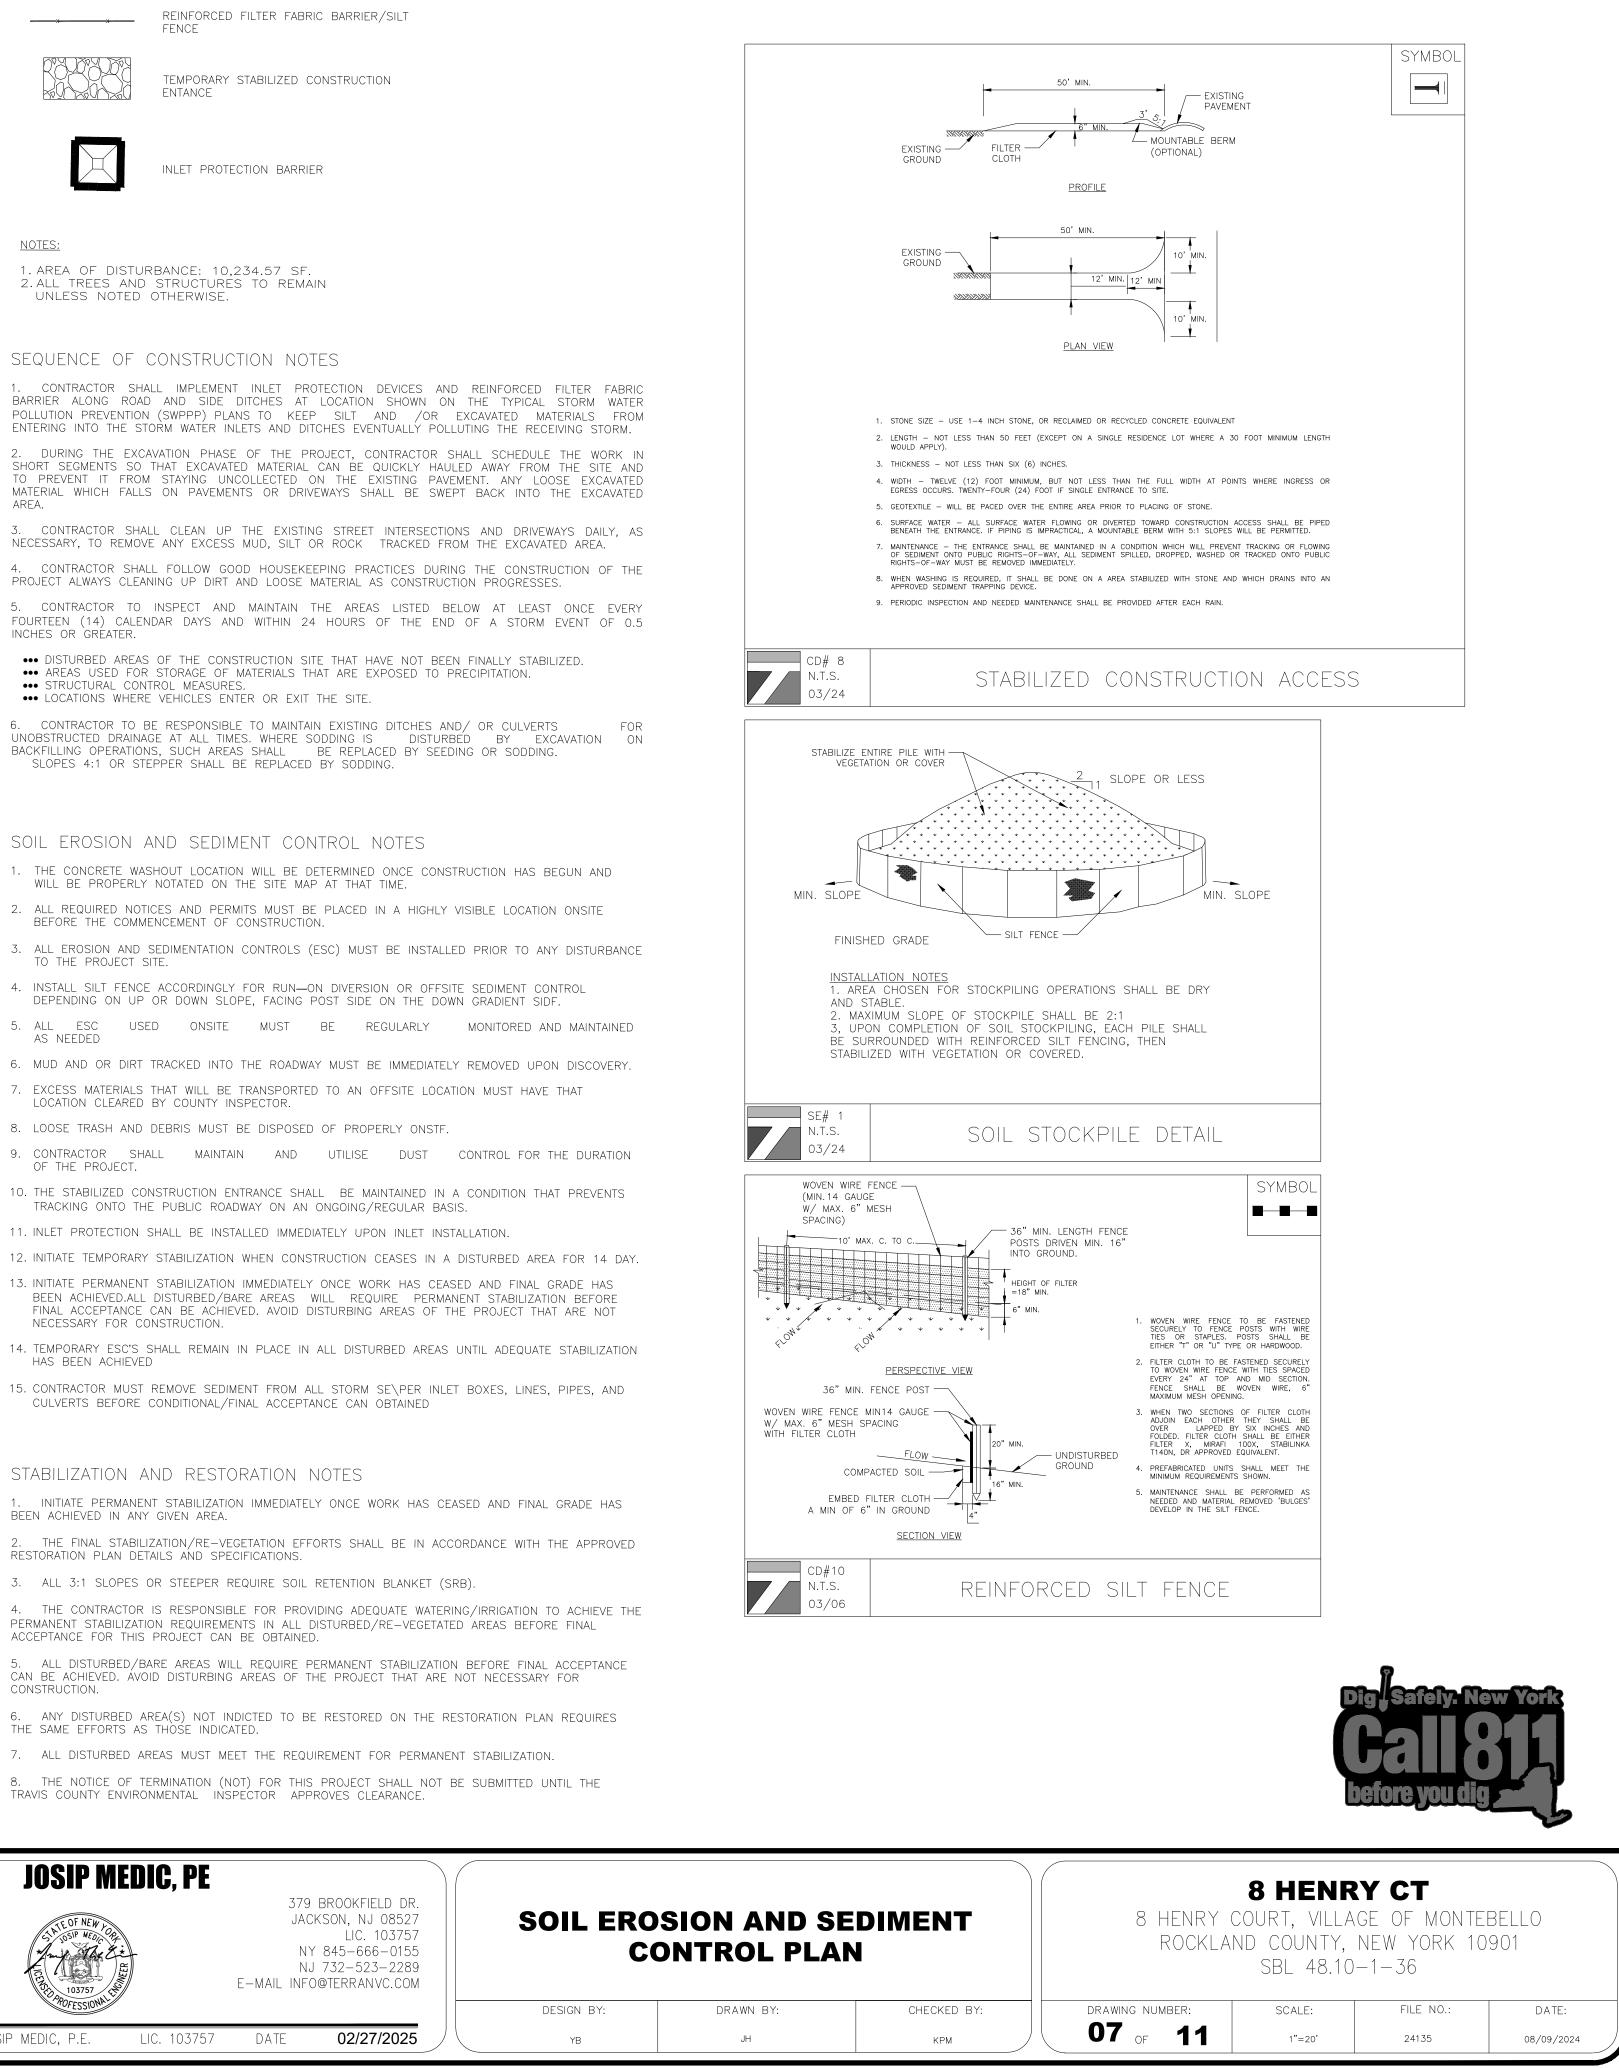



		JOSIP MEDIC, PE		
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REVISION DAT	E DR/CK	JOSIP MEDIC, P.E. LIC. 103757	DATE 02/27/2025	YB

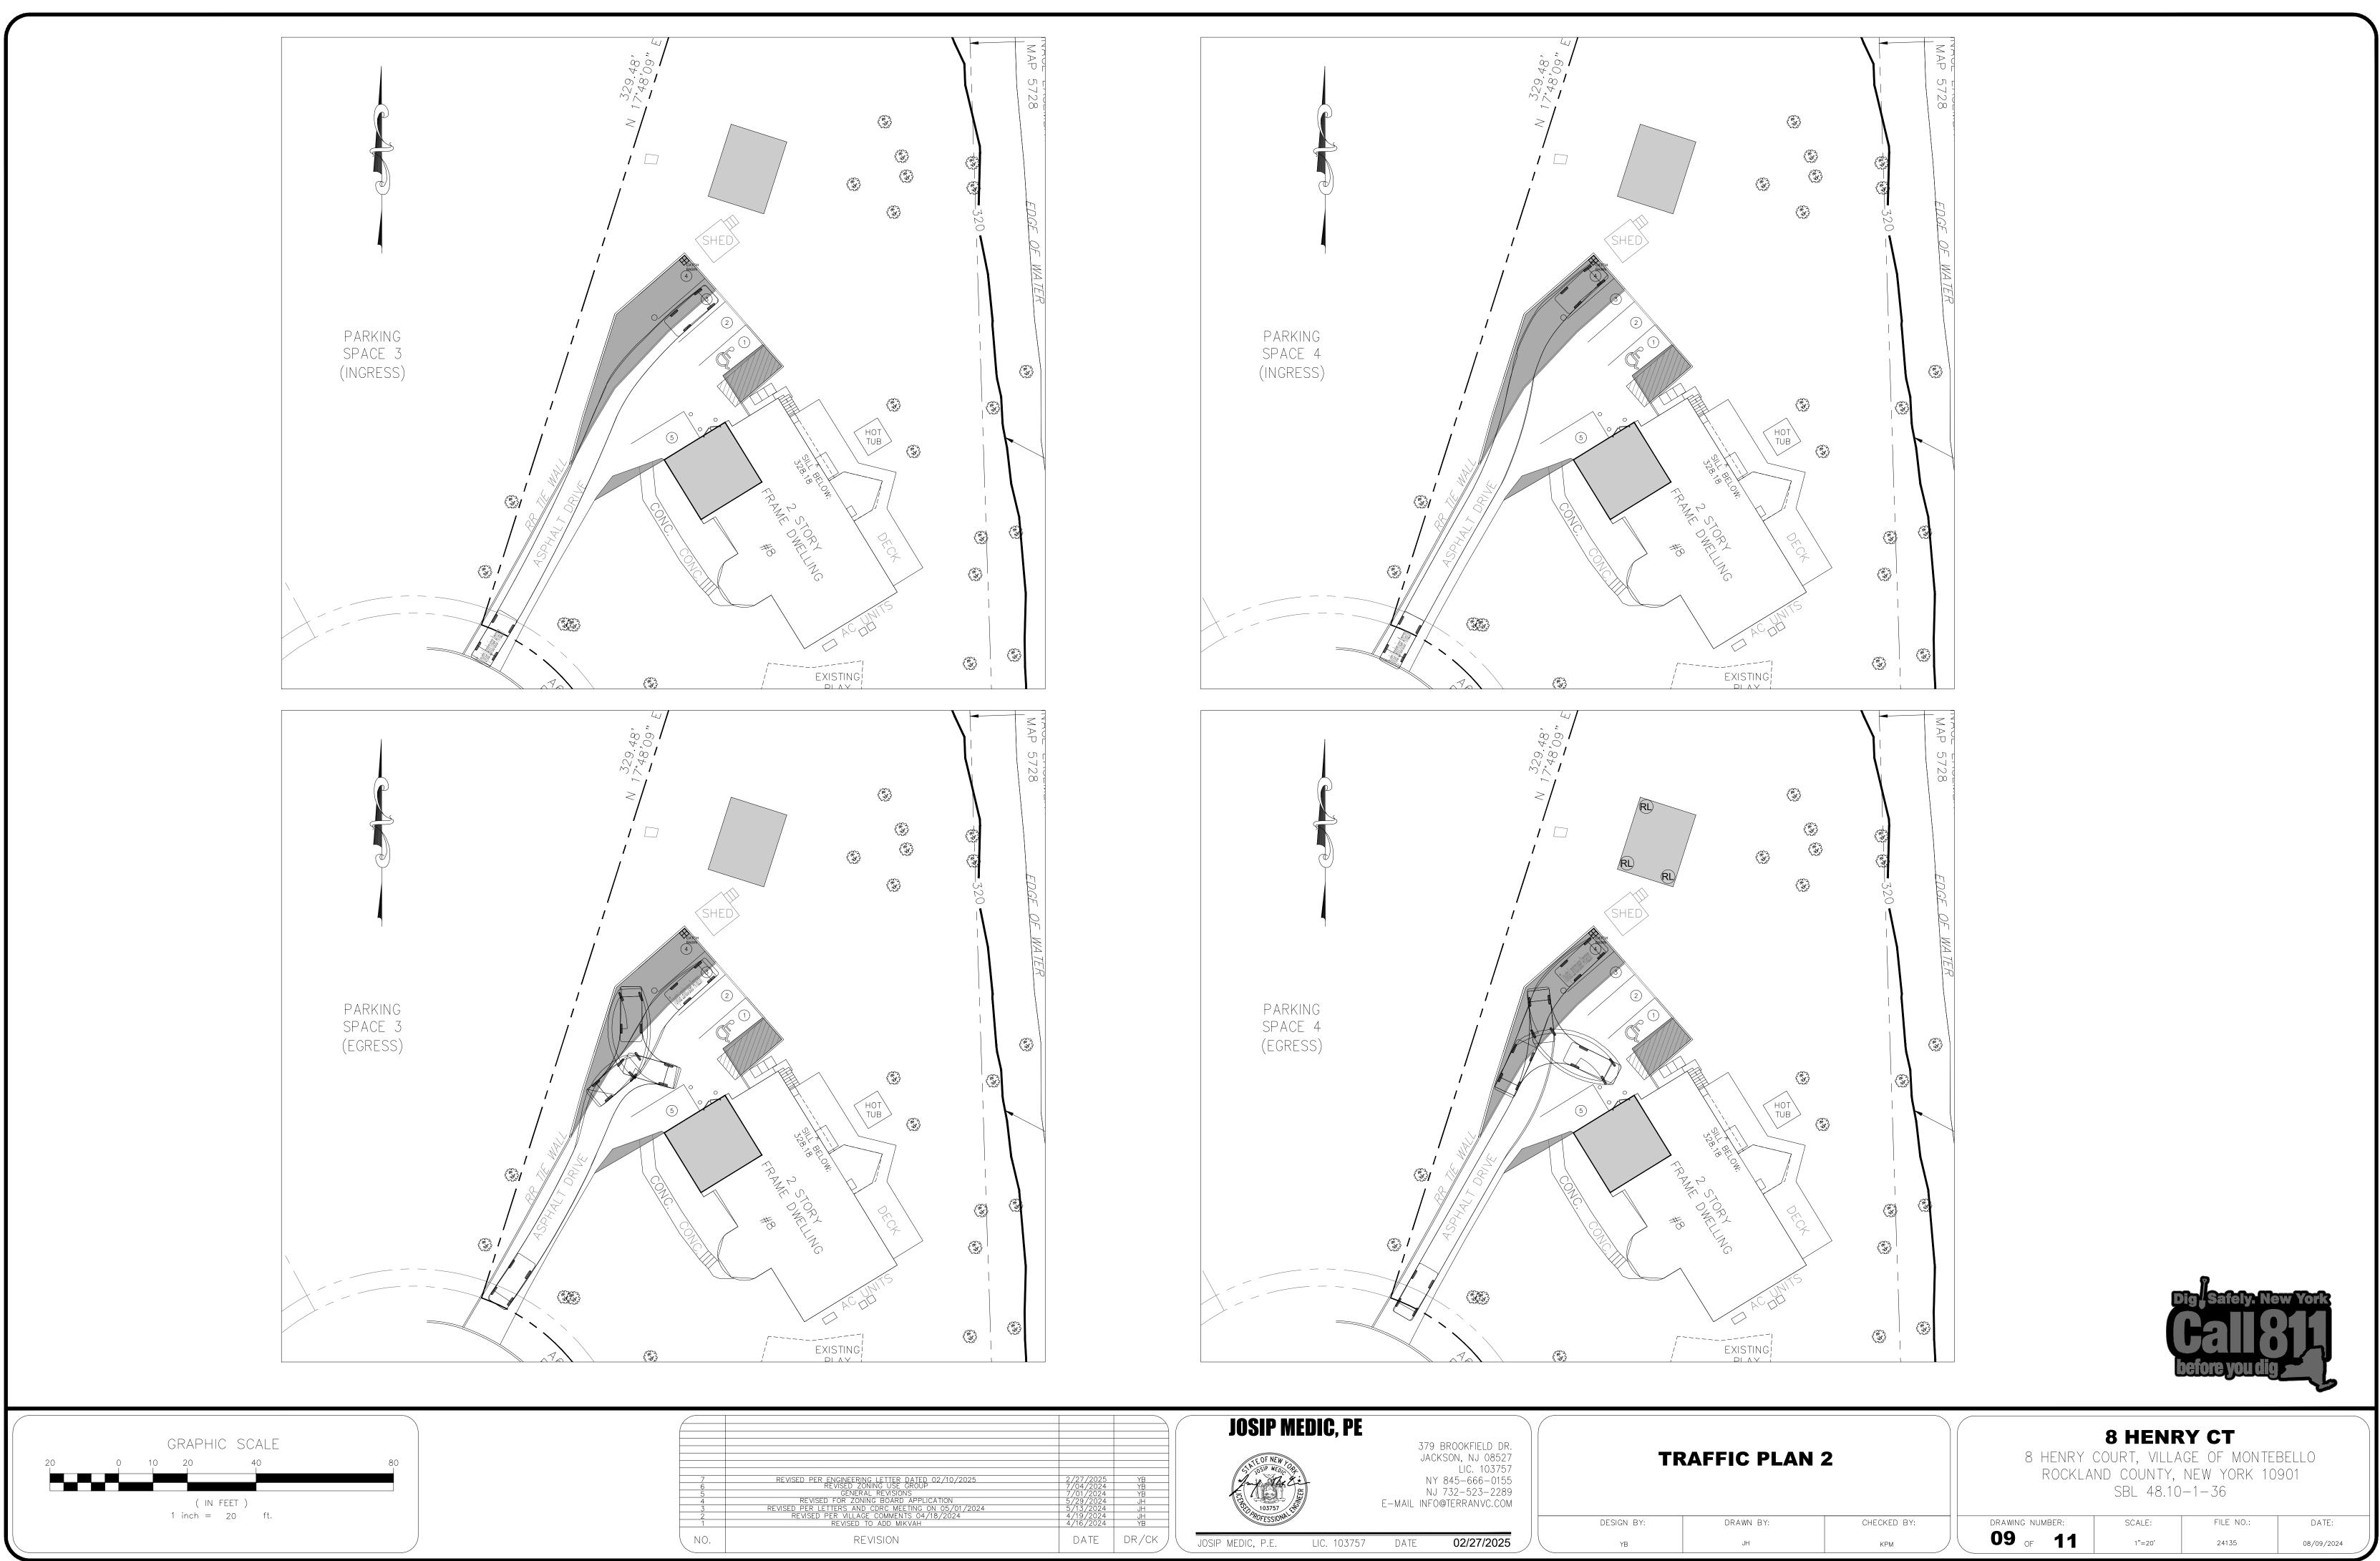EDGE OF WATER




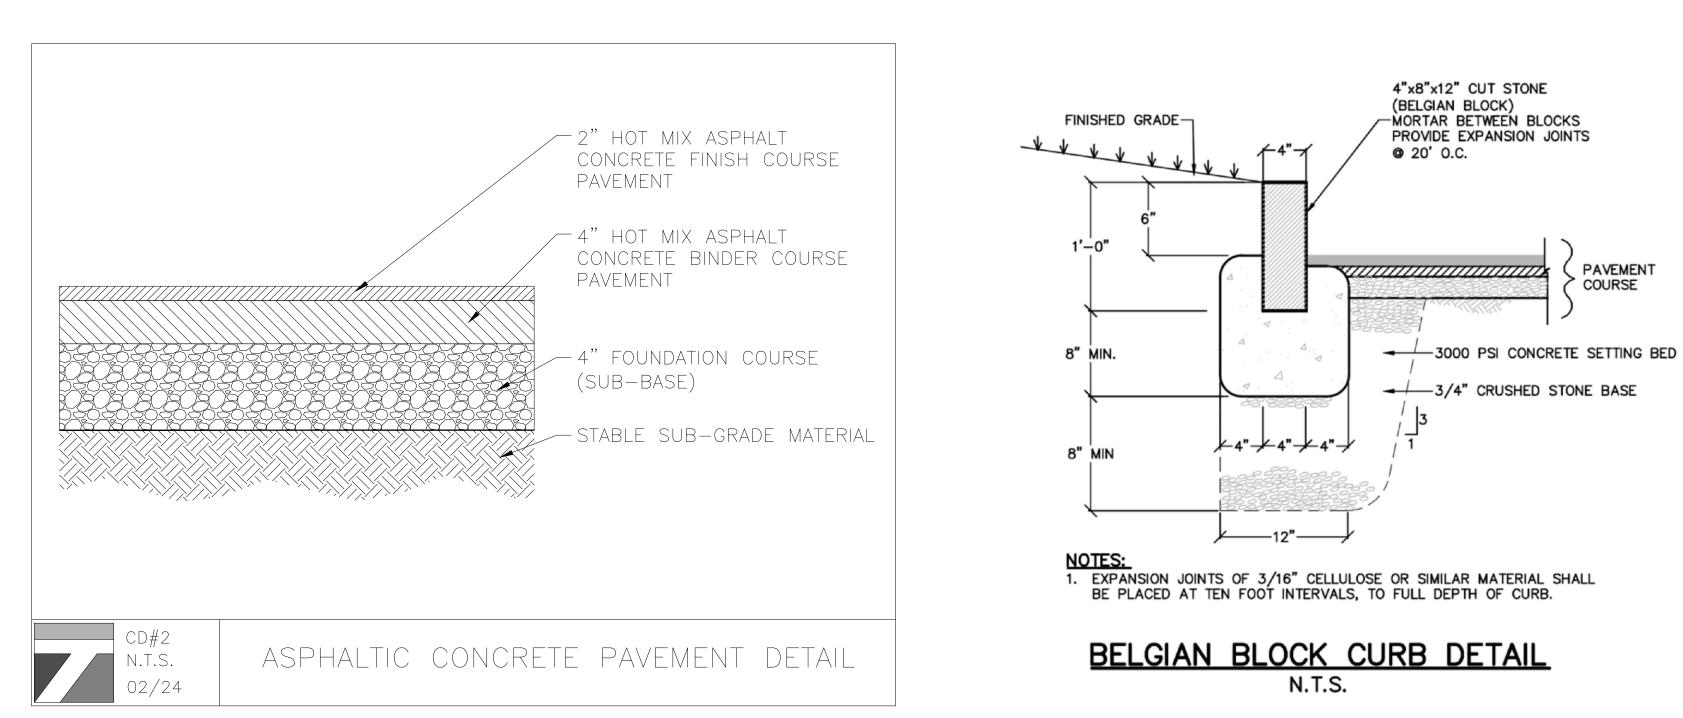

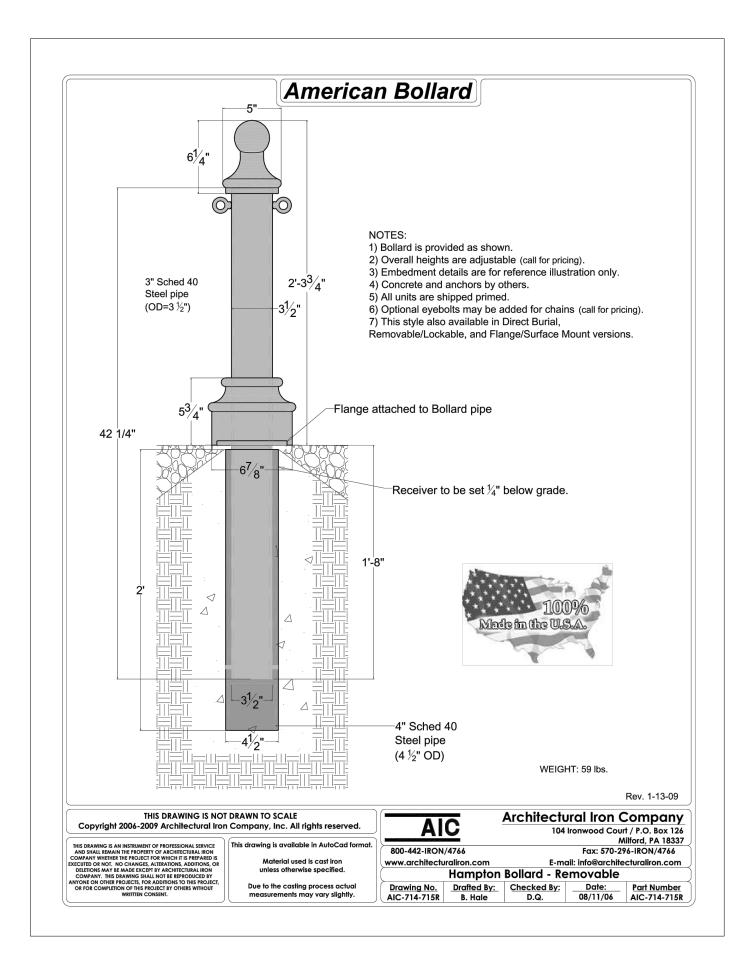

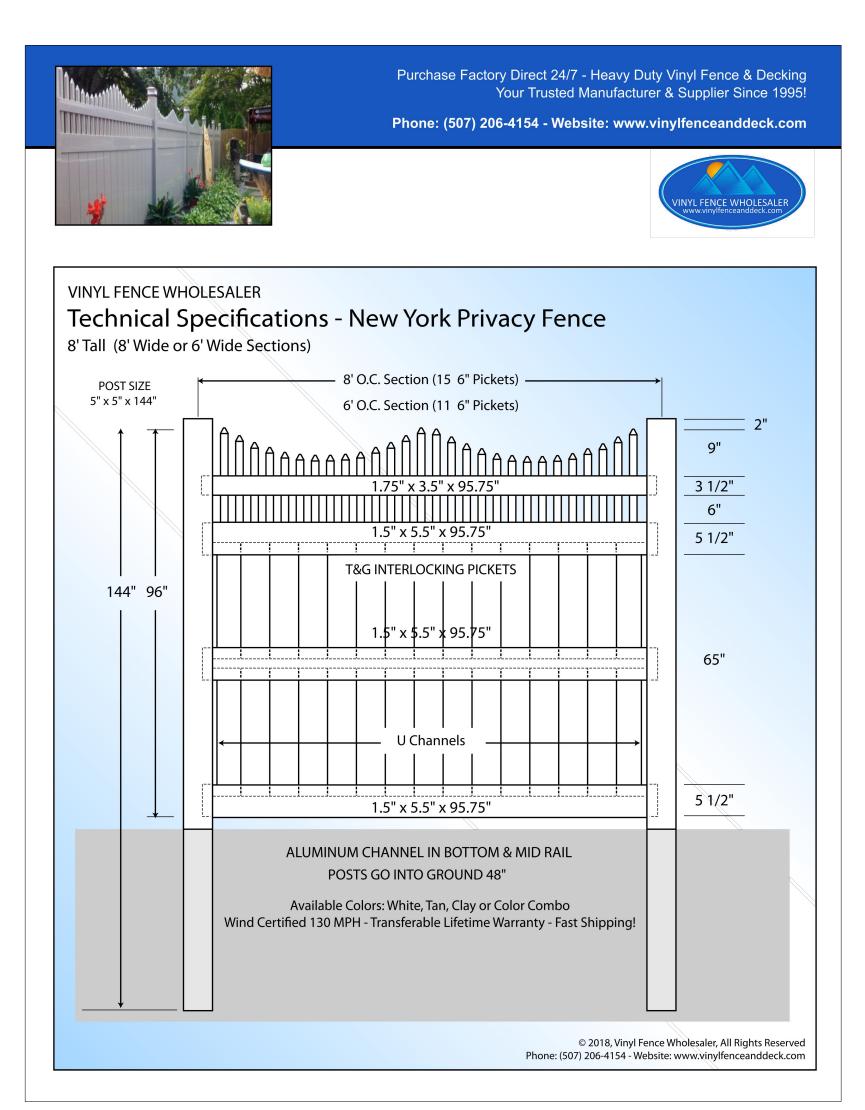

			JOSIP MEDIC, PI	Ē	
			TEOFNEW	379 BROOKFIELD DR. JACKSON, NJ 08527	
	7 REVISED PER ENGIN 6 REVISED PER ENGIN	NEERING LETTER DATED 02/10/2025 2/27/2025 SED ZONING USE GROUP 7/04/2024 GENERAL REVISIONS 7/01/2024	YB YB	LIC. 103757 NY 845-666-0155	
	4 REVISED FOR 3 REVISED PER LETTERS	R ZONING BOARD APPLICATION 5/29/2024 S AND CDRC MFETING ON 05/01/2024 5/13/2024	YB JH JH JH	NJ 732-523-2289 E-MAIL INFO@TERRANVC.COM	
	2 REVISED PER N 1 REV	VILLAGE COMMENTS 04/18/2024 4/19/2024 VISED TO ADD MIKVAH 4/16/2024	JH YB		DESIGN
	NO.	REVISION DATE	DR/CK JOSIP MEDIC, P.E. LIC. 10375	57 DATE 02/27/2025	YB

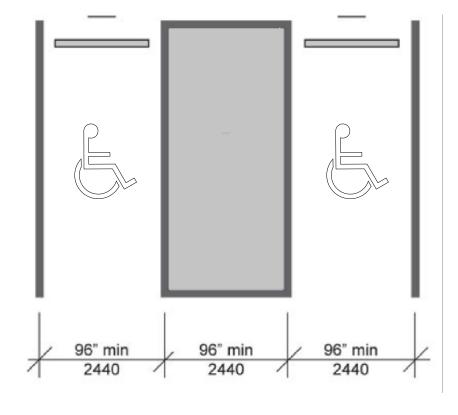


ADA PARKING SPACE LAYOUT DETAIL

Sprinter Boxwood (Buxus microphylla) Glossy foliage that stays attractive year-round. The compact rounded habit is suitable for low hedging, containers and for edging pathways and borders

Light	Height/Spread (ft)	Zone
Full sun to Full shade	2'/4'	5-9

LANDSCAPING SHRUB DETAIL TOTAL NUMBER OF SHRUBS (64)

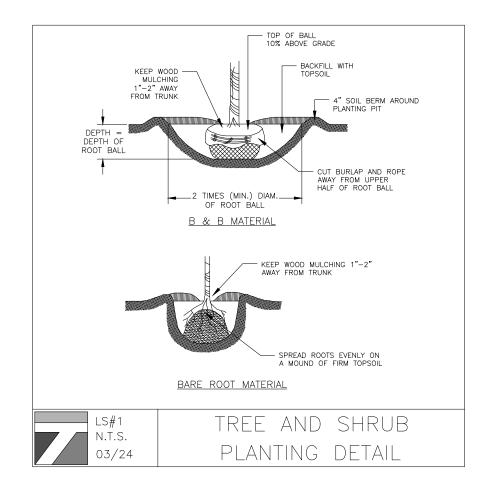



Storm Sentinel® Catch Basin Inserts are the ideal products for preventing harmful pollutants from washing into storm drains. This framed model comes complete with an adjustable steel wire frame for simple installation and removal.

- Adjustable frame
 - One-person installation and removal
 - Sits below the grate to be low-profile and unobtrusive
 - Geotextile fabric prevents contaminated sediment from washing into the drain
 - Standard versions feature overflow bypass ports for high-flow storm events, preventing storm water backup around drains
 - Reusable until product no longer maintains adequate water flow
 - No special tools required for installation
 - Complies with regulations when used in Storm Water Pollution Prevention Plans
- Optional oil-absorbing Spilltration® sorbent insert to fully capture oils and hydrocarbons
- Multiple sizes, models, and custom sizes available
- US Patent No. 10,384,155

Part Number	Min Dimensions in. (cm.)	Max Dimensions in. (cm.)	Absorption Cap gal. (L.)
	Standard (Sed	iment, Trash, Debris)	e
4341	16x20 (41x51)	28x36 (71x97)	N/A
4343	25x25 (64x64)	42x42 (107x107)	N/A
	No Overflow (Se	diment, Trash, Debris)	
4341-NO	16x20 (41x51)	28x36 (71x97)	N/A
4343-NO	25x25 (64x64)	42x42 (107x107)	N/A
	Oil Absorbing (Oils	, Sediment, Trash, Debris)	
4341-IB	16x20 (41x51)	28x36 (71x97)	0.23 (0.87)
	25×25 (61×61)	10~107~1071	0.22 (0.82)



8 HENRY CT DETAILS SHEET 8 HENRY COURT, VILLAGE OF MONTEBELLO ROCKLAND COUNTY, NEW YORK 10901 SBL 48.10-1-36 DRAWING NUMBER: SCALE: FILE NO.: DATE: DRAWN BY: CHECKED BY: **11** OF **11** 1"=20' 24135 08/09/2024 JH KPM