Proposed New Addition For:

17 Sterling Forest Ln.

Montebello

Rockland County, New York

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PROJECT:

Proposed New Addition For:

7 Sterling Forest Ln


Montebello

Rockland County, New York


DRAWN BY:	Shlome Glauber
DATE:	7/15/2024
DATE:	8/2/2024
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DATE:	1/13/2025
DATE:	3/10/2025


RODGER BRADLEY,
ARCHITECTS
NYS LIC. NO. 013-832
50 PLATTS HILL ROAD
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NOT LESS THAN 7" INTO CONCRETE OR MASONRY. THE BOLTS SHALL BE LOCATED IN THE MIDDLE 3'RD OF THE WIDTH OF THE PLATE.
BOLTS SHOULD BE SPACED NOT MORE THAN G' ON CENTER, BE TIGHTENED ON EACH BOLT TO PLATE.

OR APPROVED ANCHORS. SPACED TO PROVIDE EQUIVALENT

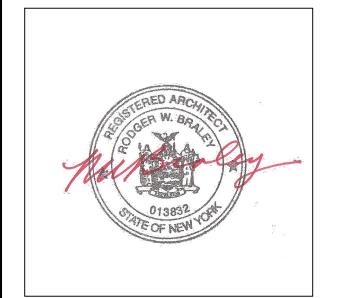ANCHORAGE AS THE STEEL BOLTS.

BOLTS SHALL BE EMBEDDED

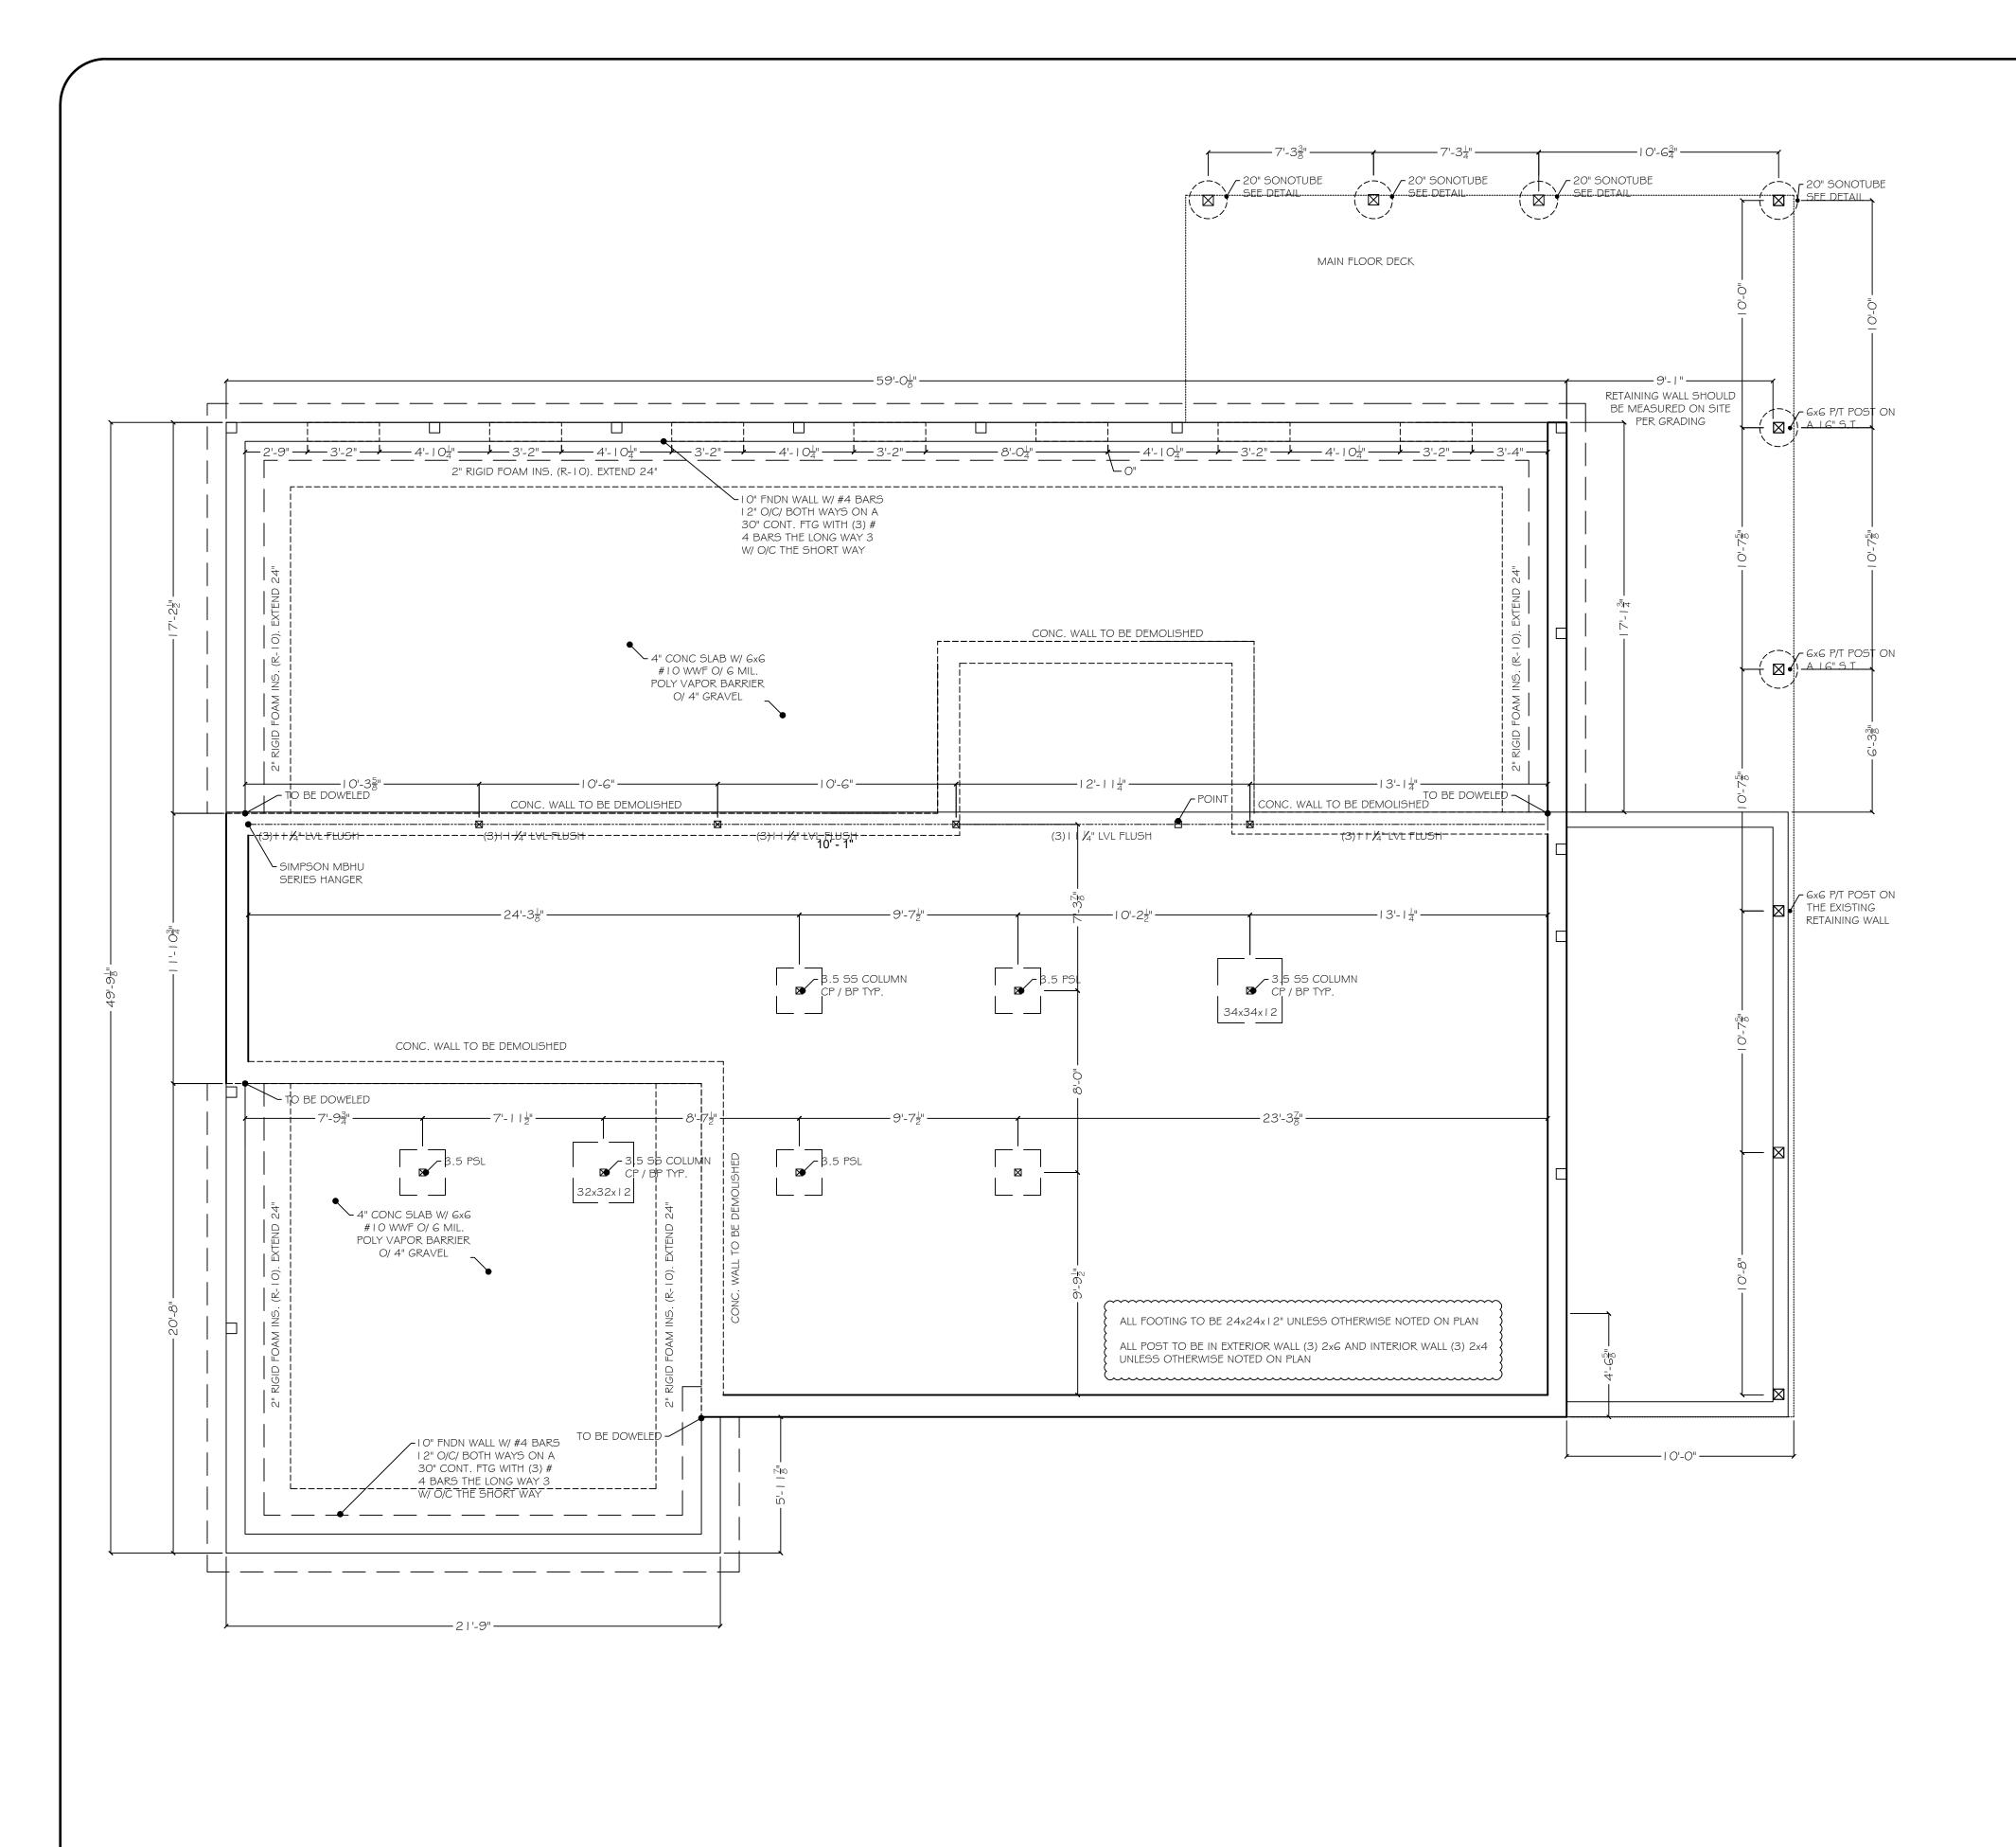FOUNDATION PLATES OR SILS SHALL BE BOLTED OR ANCHORED AND THERE SHOULD BE NOT LESS THAN 2 BOLTS OR ANCHOR TO THE FOUNDATION NOT LESS THEN 2" DIAMETER STEEL BOLTS STRAPS PER PIECE, WITH I BOLT OR ANCHOR STRAP LOCATED NOT MORE THAN 12" OR LESS THAN 4" FROM EACH END BOLTS IN SIL PLATES OF BRACED WALL LINES IN STRUCTURE OVER TO A 95% COMPACTION, TYP. 2 STORIES ABOVE GRADE SHALL BE SPACED NOT MORE THAN 4' O.C. A PROPERLY SIZED NUT AND WASHER SHOULD

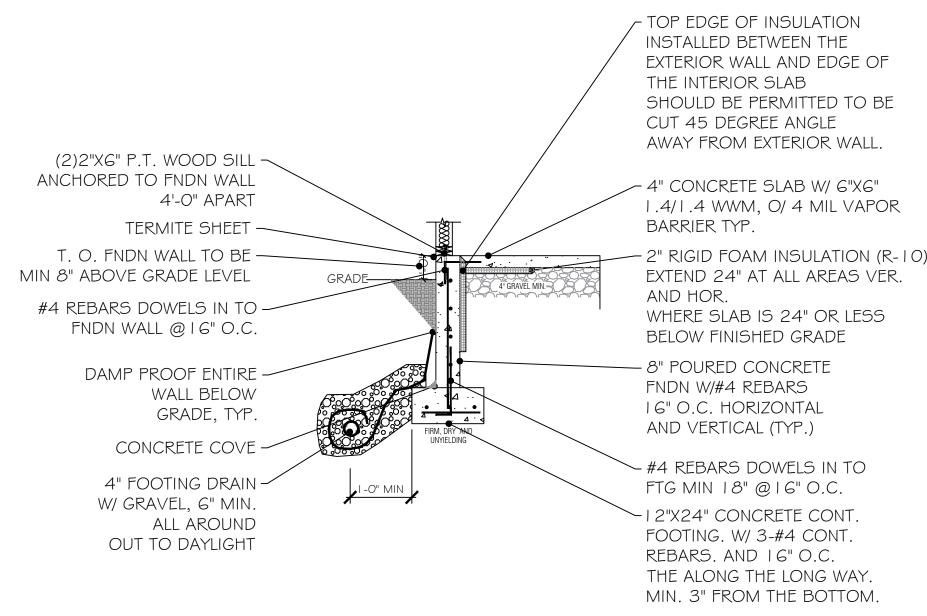FOOTINGS TO BE O/ UNDISTURBED EARTH, IF EARTH IS DISTURBED INSIDE OR OUTSIDE THE FOUNDATION, INSTALL STRUCTURAL FILL AND COMPACT IN 8 INCH LIFTS WHEN T.O. GRADE EXCEEDS 4'6" OF FOOTING

FNDN TO BE 10" WIDE W/ 2 ROWS #4 REBARS VER. AND HOR. @16" O.C.


2 FOUNDATION / FOOTING DETAIL SCALE: N.T.S.

LENGTH AND WIDTH OF TOP — PLATE TO BE DETERMINED BY SIZE OF BEAM. SEE SIMPSO STRONG TIE CHART FOR REFERENCE TYPICAL CCOS INSTALLATION CONNECTING A 3-PLY LVL AND A STEEL COLUMN

COLUMN CAP BY SIMPSON TIES, LCC/CCOS TYPE OR APPROVED EQUAL BY BUILDING DEPARTMENT


POST CAP DETAIL

SCALE: 1/4" = 1'0"

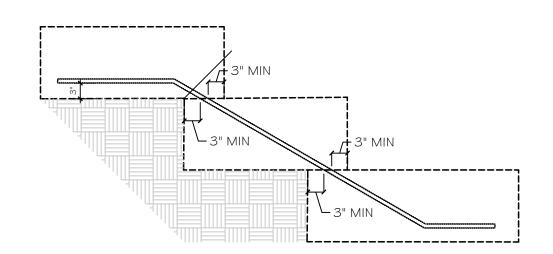

STEP FOOTING DETAIL

SCALE: 1/4" = 1'0"

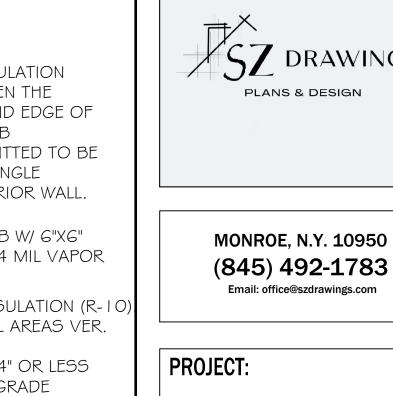


Forest terling

DRAWN BY:	Shlome Glauber
DATE:	7/15/2024
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RODGER BRADLEY. ARCHITECTS NYS LIC. NO. 013-832 50 PLATTS HILL ROAD NEWTOWN, CT 06470 T: 203.426.9918

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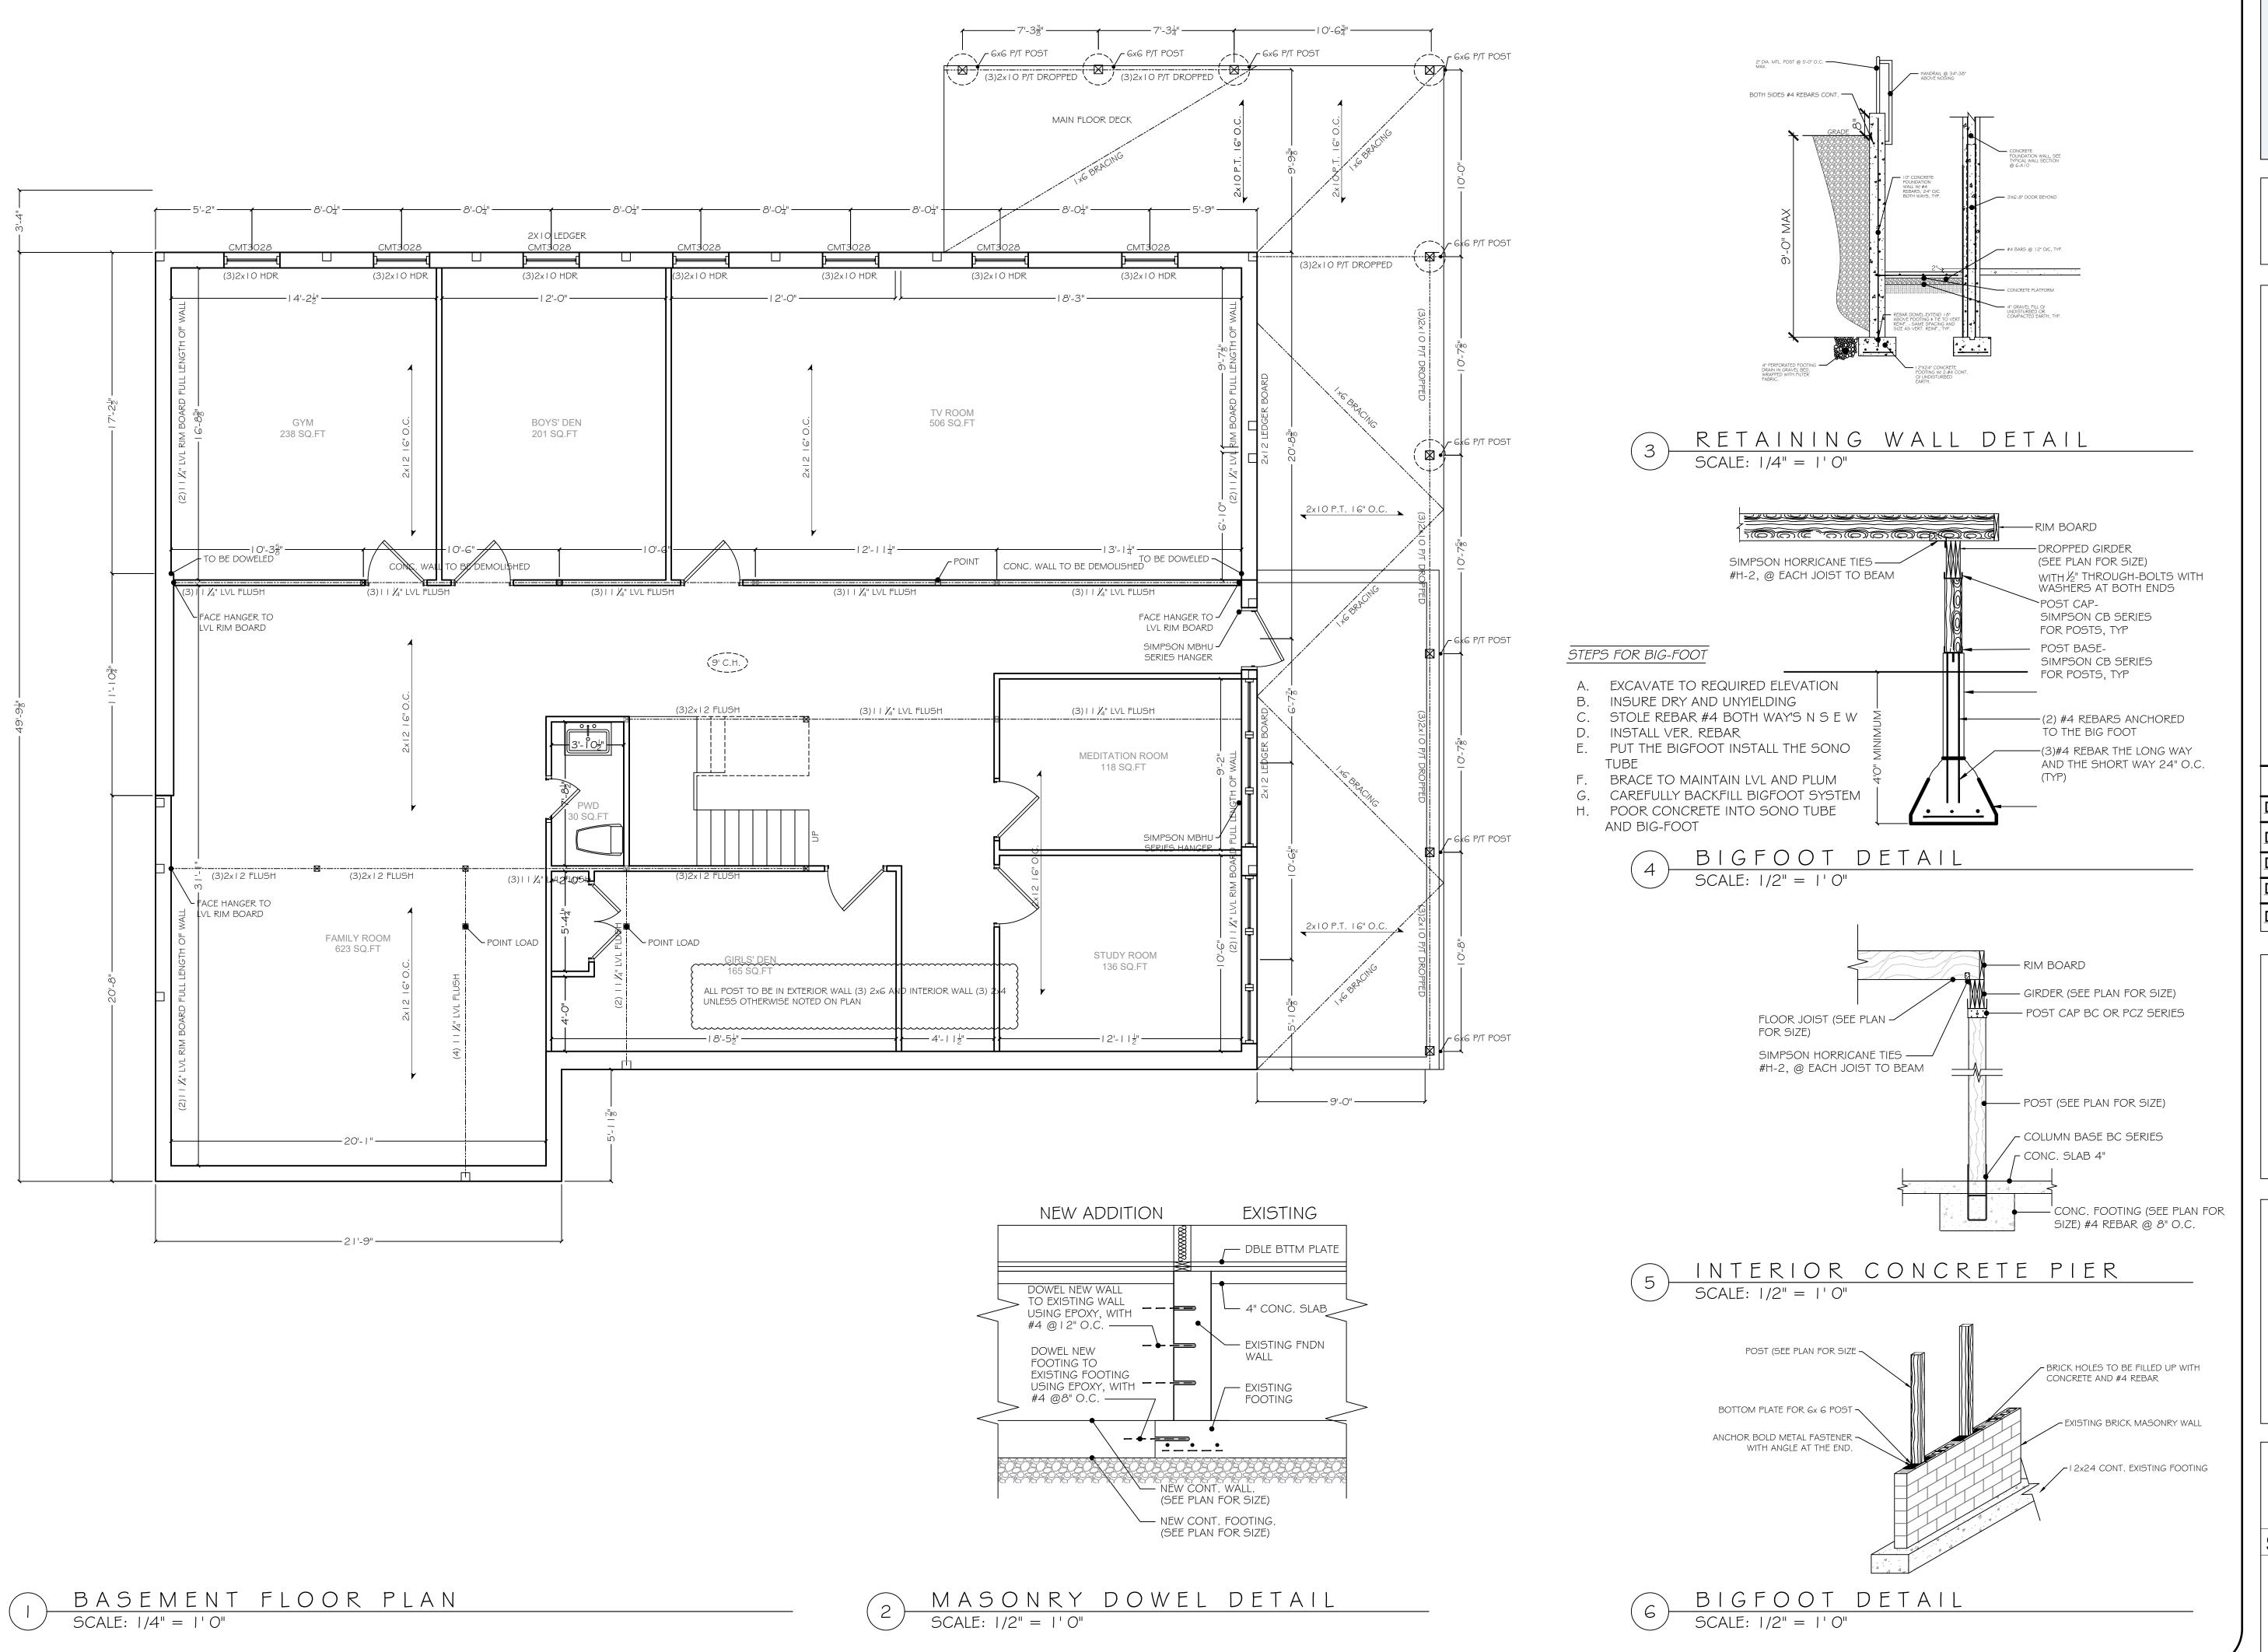


DESCRIPTION:

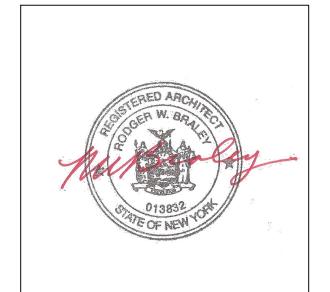A-101

SCALE AS NOTED

FOUNDATION FOOTING PLAN SCALE: 1/4" = 1'0"





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PROJECT:

7 Sterling Forest Ln
Montebello
Rockland County, New York

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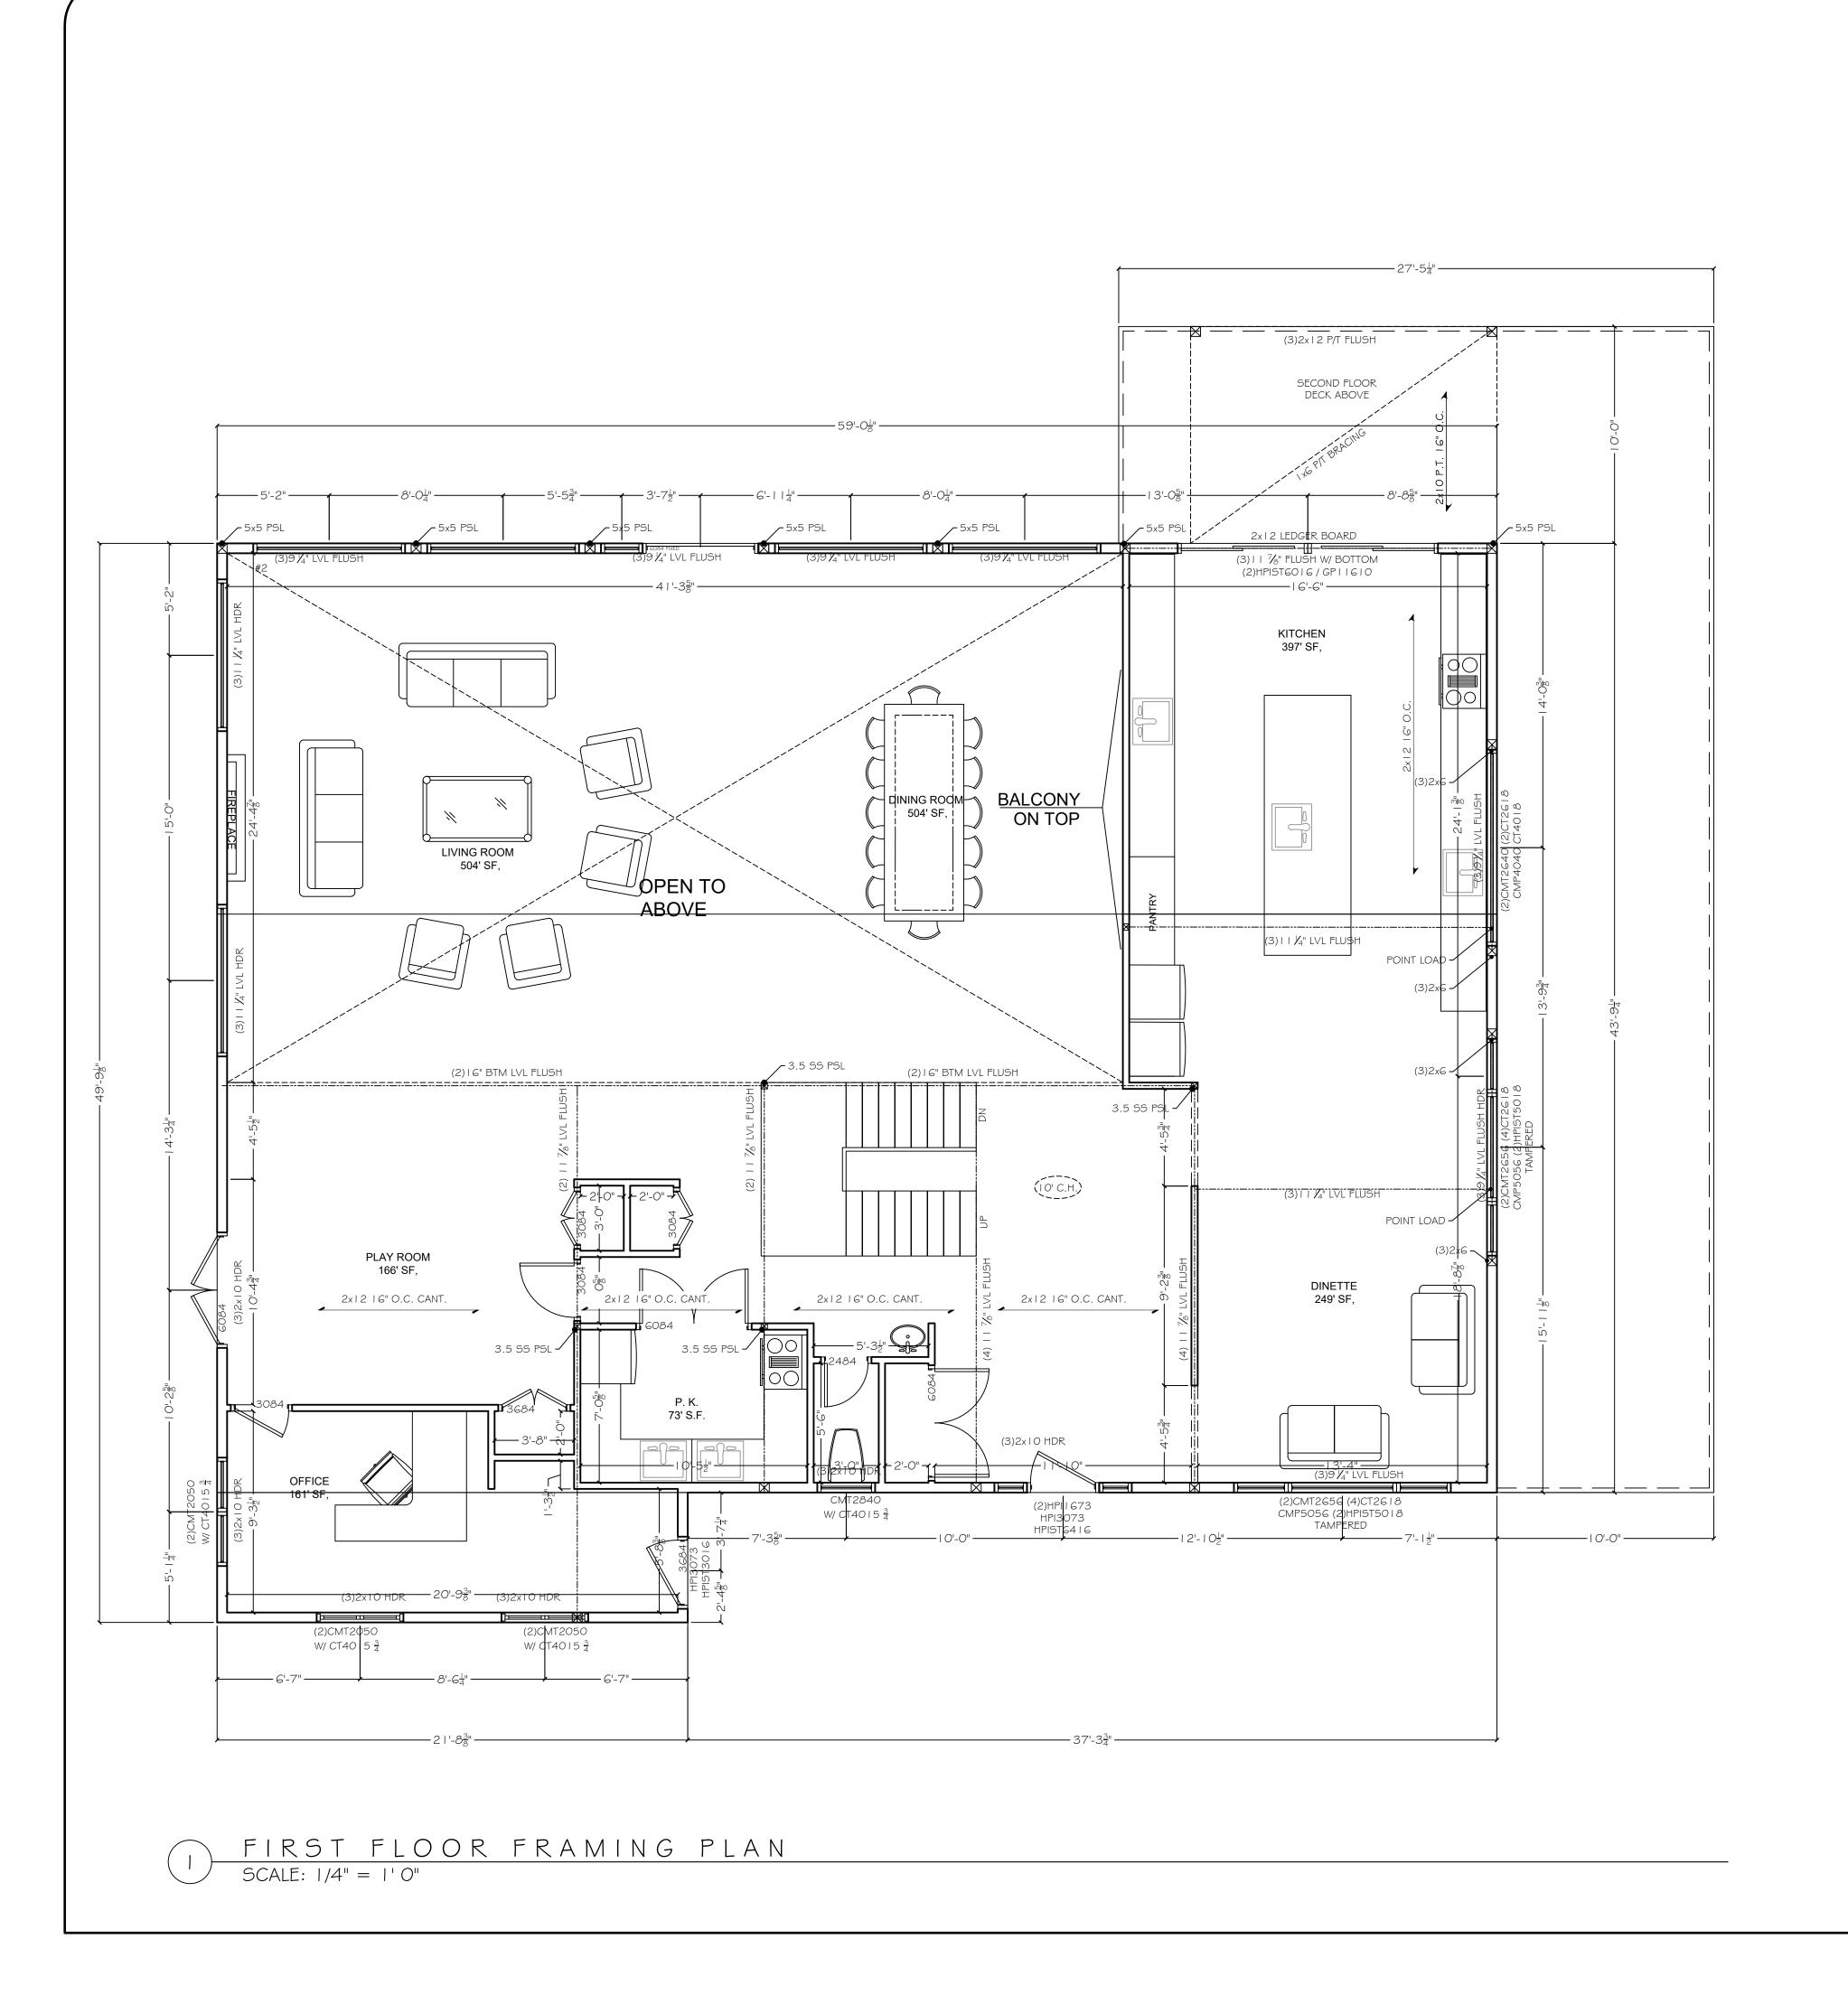
NEWTOWN, CT 06470 T: 203.426.9918


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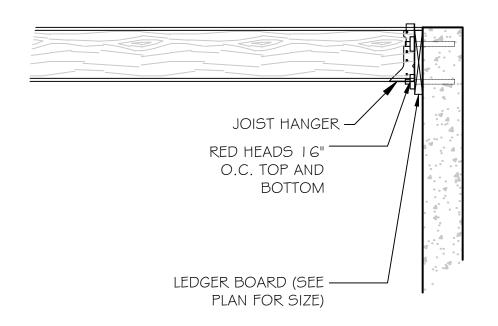
DESCRIPTION:

A-102






ANGLE IRON SHELF SCALE: 1/4" = 1'0"

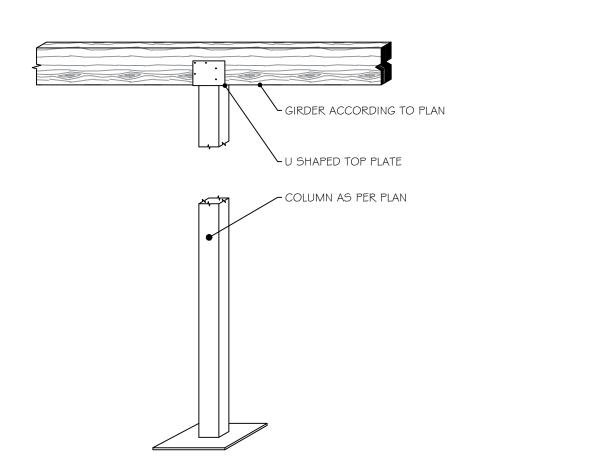


LEDGER BOARD TO CONCRETE

SCALE: 1/4" = 1'0"

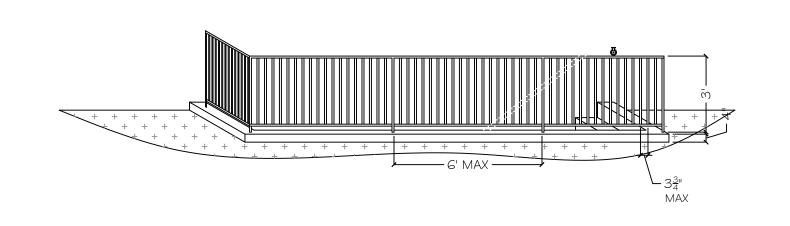

STAIR WELL ELEVATION

SCALE: 1/4" = 1'0"

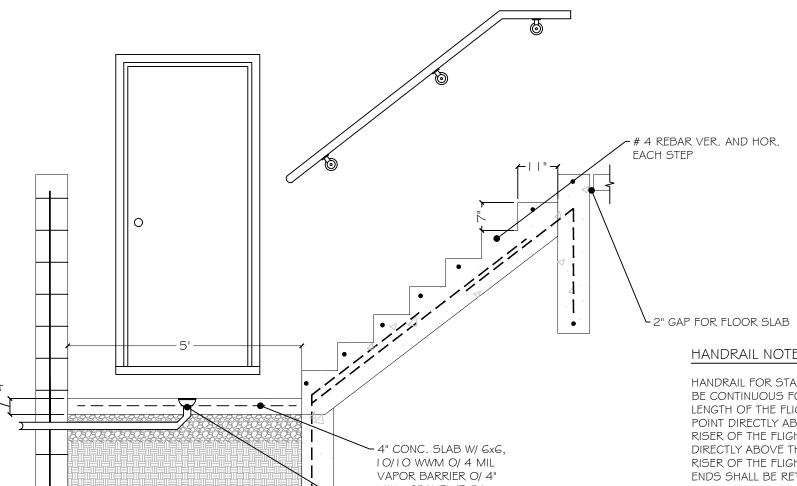

HANDRAIL FOR STAIRWAYS SHALL
BE CONTINUOUS FOR THE FULL
LENGTH OF THE FLIGHT, FROM A
POINT DIRECTLY ABOVE THE TOP
RISER OF THE FLIGHT TO A POINT
DIRECTLY ABOVE THE LOWEST
RISER OF THE FLIGHT. HANDRAIL
ENDS SHALL BE RETURNED OR
SHALL TERMINATE IN NEWEL
POSTS OR SAFETY TERMINALS.
HANDRAIL SHALL BE PERMITTED
TO BE INTERRUPTED BY A NEWEL
POST AT THE TURN. MIN. GRAVEL (TYP.) TO DRAIN OUT TO DAYLIGHT

CONC. STAIR DETAIL SIDE VIEW

SCALE: 1/4" = 1'0"

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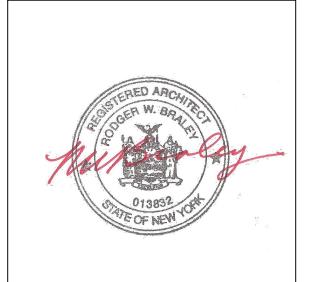
Proposed New Addition For:
Sterling Forest I

DRAWN BY:	Shlome Glauber
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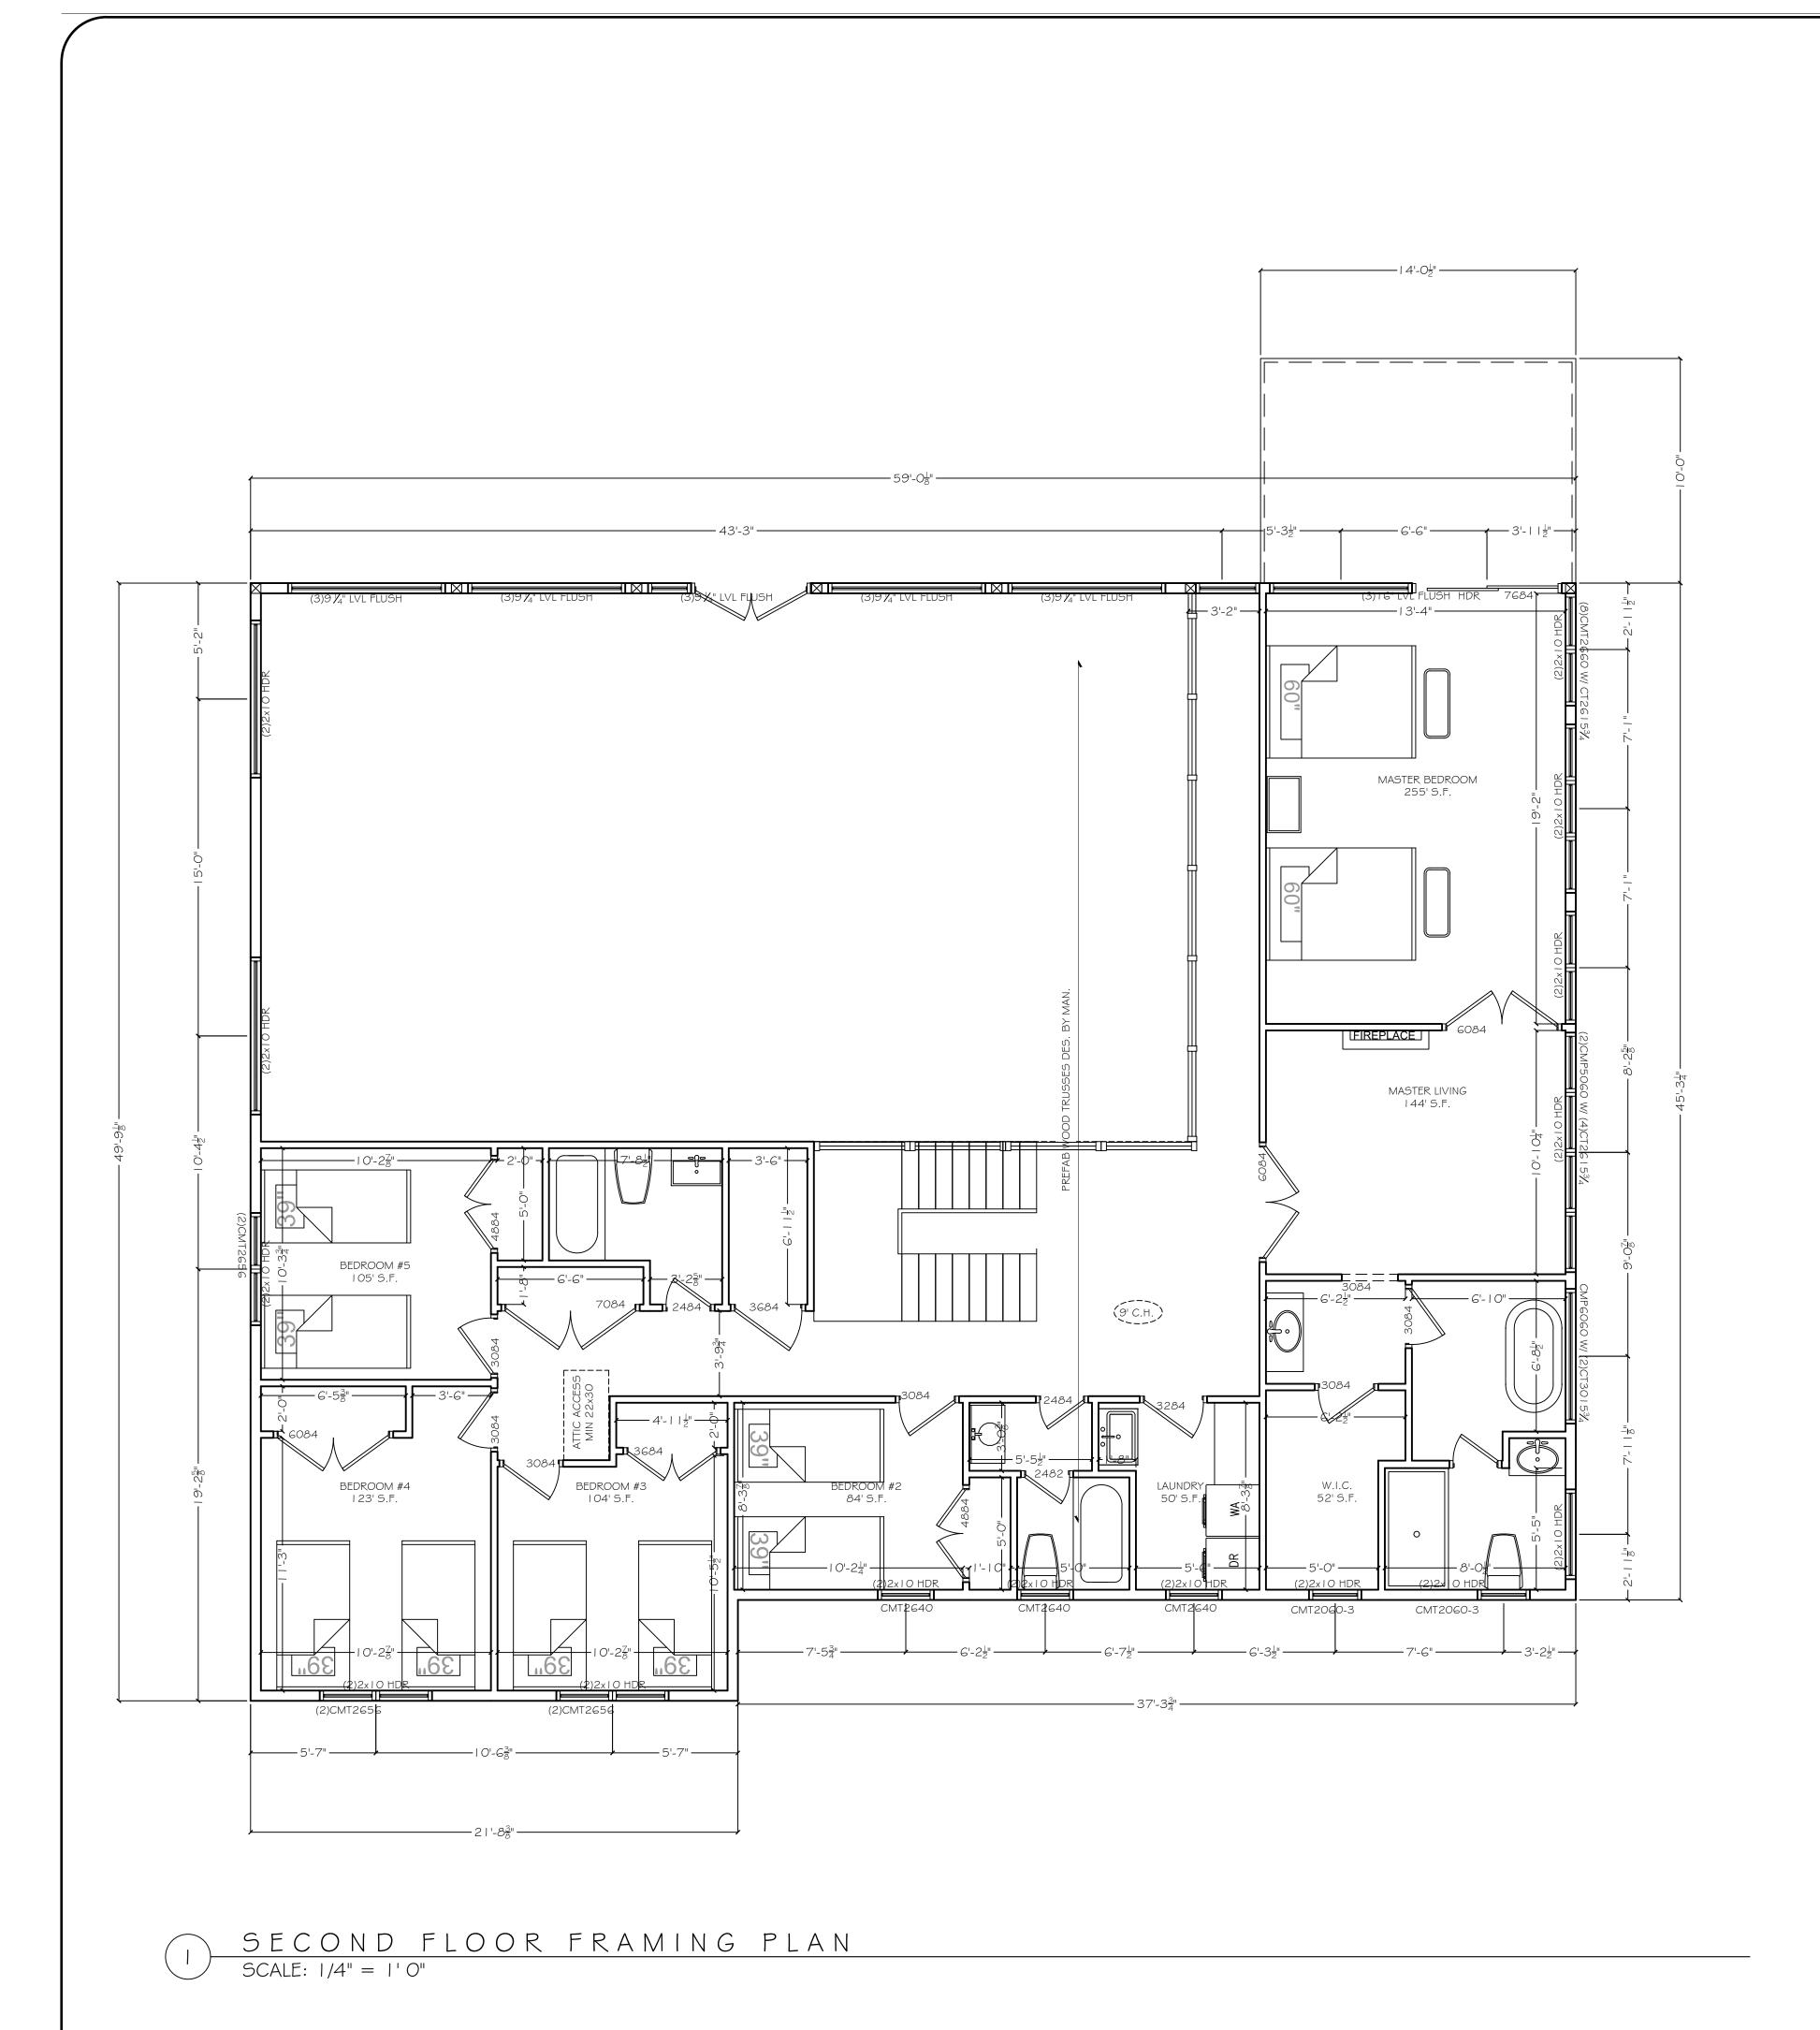
Email: rbraley2@sbcglobal.net




DESCRIPTION:

HANDRAIL NOTE:


A-103



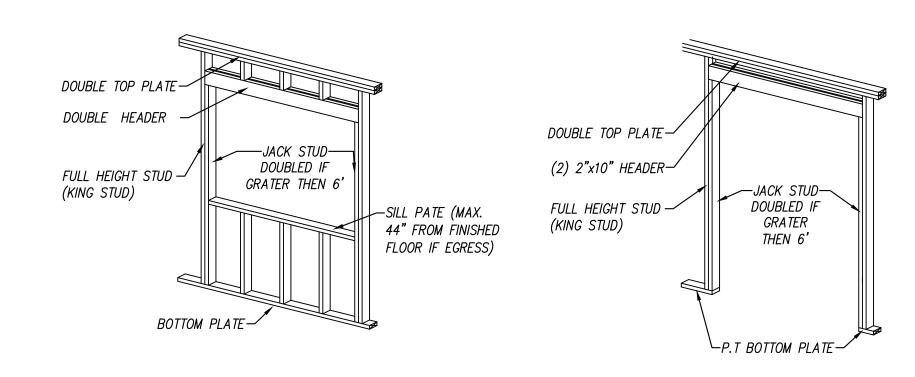


OPENINGS FRAMING DETAILS

SCALE: 1/4" = 1'0"

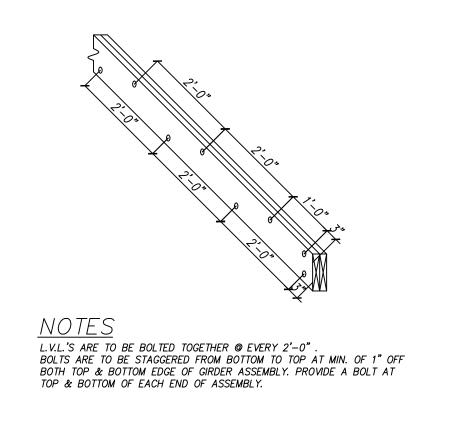

LVL BOLT DETAIL

SCALE: 1/4" = 1'0"

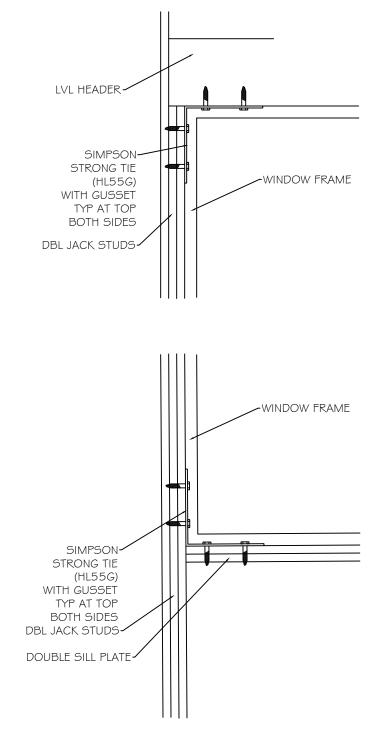

3 WINDOW TOP AND BOTTOM DETAIL

SCALE: 1/4" = 1'0"



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PRO IFCT:


7 Sterling Forest Ln
Montebello
Ockland County, New York

DRAWN BY:	Shlome Glauber
DATE:	7/15/2024
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DESCRIPTION:

A-104



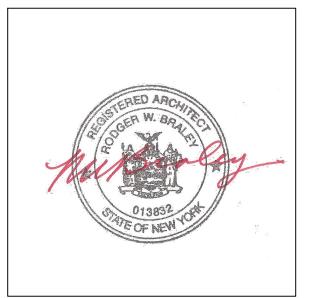

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PROJECT:

Proposed New Addition For:

17 Sterling Forest Ln.


Montebello
Rockland County, New York

DRAWN BY:	Shlome Glauber
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ARCHITECTS
NYS LIC. NO. 013-832
50 PLATTS HILL ROAD
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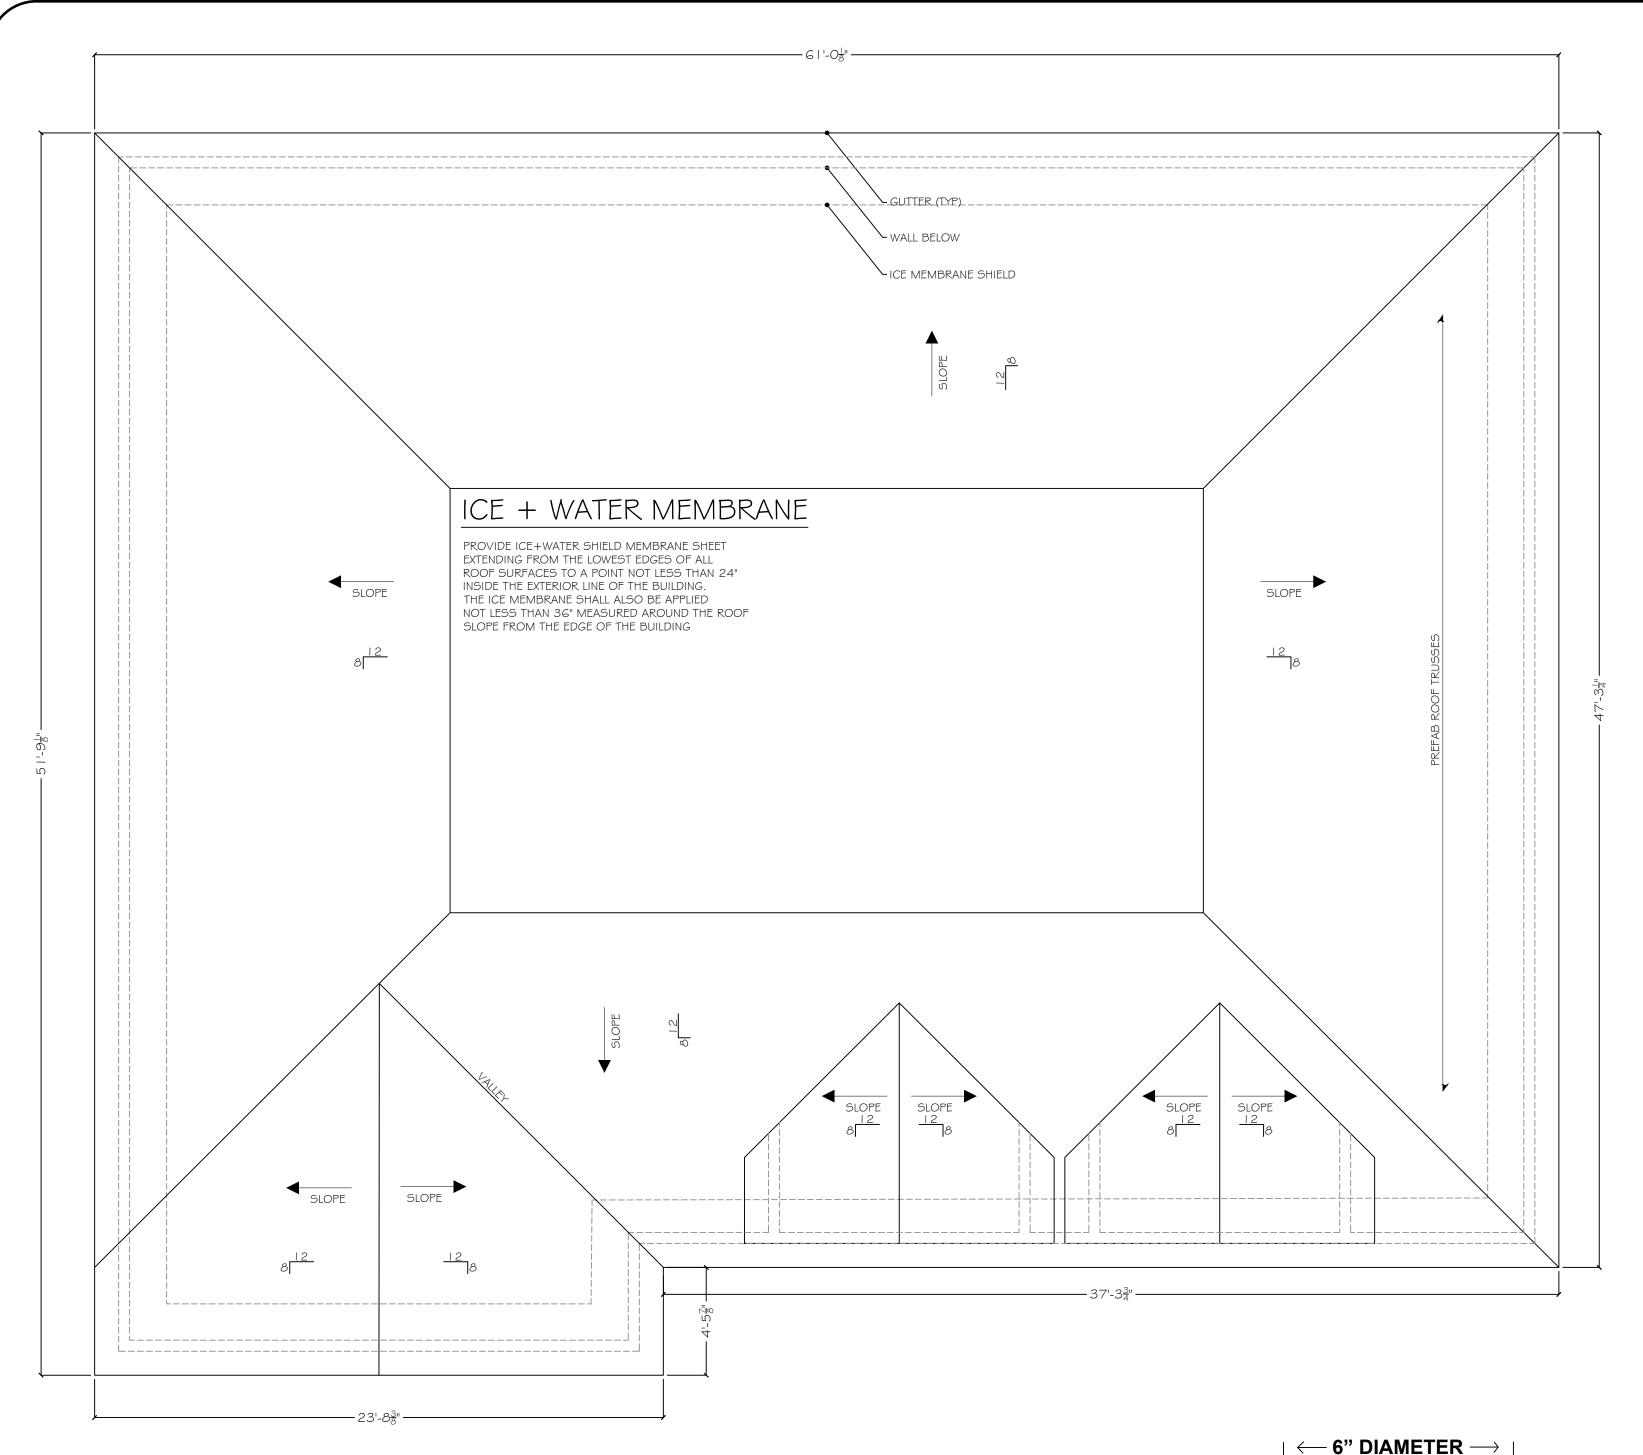
Email: rbraley2@sbcglobal.net

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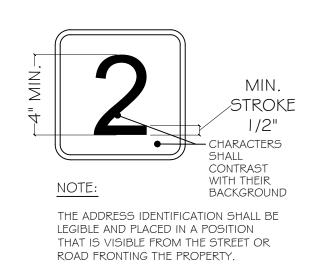
DESCRIPTION:

A-105

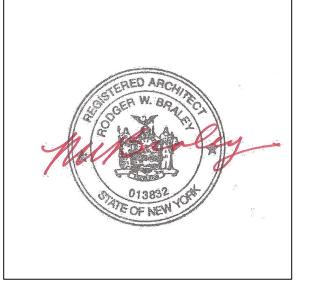

PROPOSED ROOF PLAN

SCALE: 1/4" = 1'0"



NOTE 1: CONFIRM LOCATION WITH BUILDING CODE OFFICIAL CHAPTER 33, PART 1264 OF THE NYS BUILDING CODE INSTALL IDENTIFICATION SIGN FOR BUILDINGS UTILIZING TRUSS TYPE CONSTRUCTION INTERNATIONAL RESIDENTIAL CODE OF 2020, SECTION R302.13 - PROTECTION OF FLOORS

REFLECTIVE REI

FLOOR FRAMING, INCLUDING

ROOF FRAMING

"FR" FLOOR AND ROOF FRAMING

GIRDERS AND BEAMS

The construction type

"I", "II", "III", "IV"or "V"

to indicate the construction

designation shall be

classification of the

structure under


INTERNATIONAL RESIDENTIAL CODE OF 2020, SECTION R302.13 - PROTECTION OF FLOORS EXCEPTION 4 - WOOD FLOOR ASSEMBLIES USING DIMENSIONAL OR STRUCTURAL COMPOSITE LUMBER EQUAL TO OR GREATER THAN 2" x 10" NOMINAL. CODE OFFICIAL DETERMINATION - COVER UNDERSIDE OF TJI JOISTS PER CODE WITH ½" GYP. BD. CONTRACTOR TO SUBMIT JOIST MANUFACTURER SPECIFICATIONS TO THE BUILDING CODE OFFICIAL PRIOR TO ORDER FOR REVIEW.

ADDRESS IDENTIFICATION DETAIL

SCALE: 1/4" = 1'0"

TRUSS TYPE CONS. SIGN DETAIL

SCALE: 1/4" = 1'0"

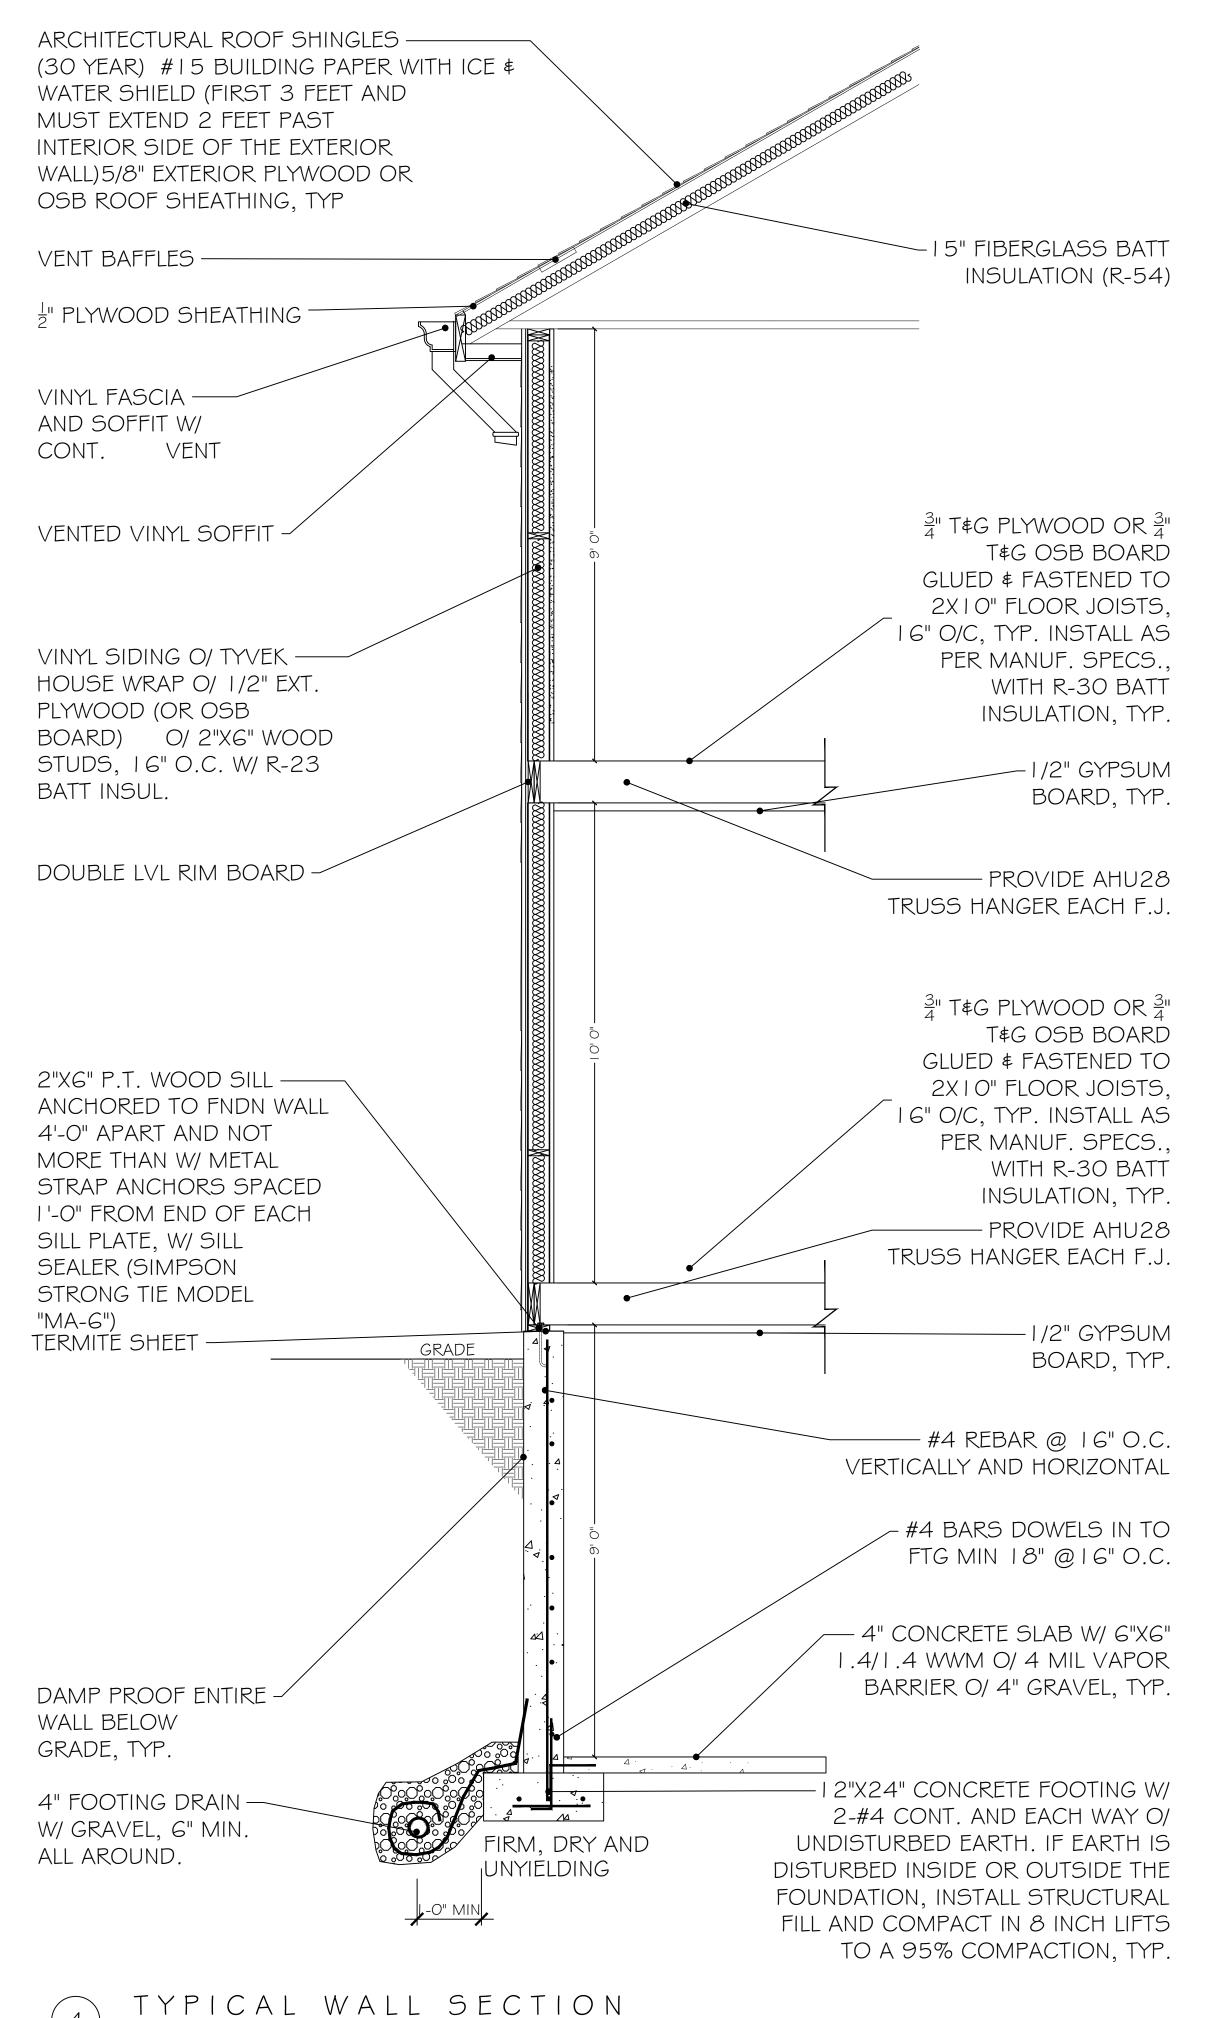



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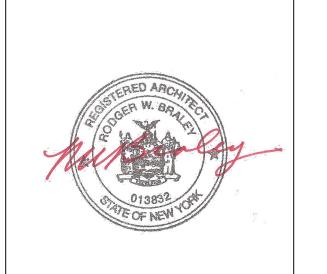
17 Sterling Forest Ln
Montebello
Rockland County, New York

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DESCRIPTION:

A-106

SCALE AS NOTED

SCALE: 1/2" = 1'0"


REFLECTIVE WHITE

STROKE

COMPONENTS THAT ARE OF


TRUSS TYPE CONSTRUCTION

DESIGNATION FOR STRUCTURAL

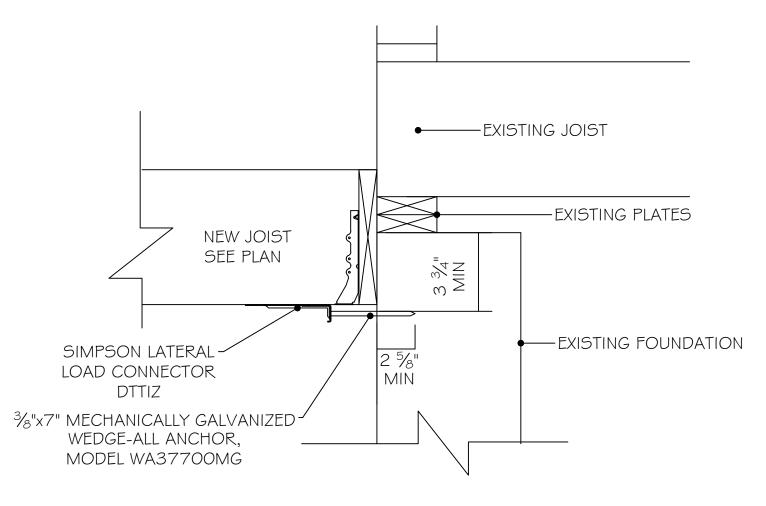


OPTION A

PROVIDE 4 CONNECTOR PER LEDGER EVENLY SPACED AND INSTALLED WITHIN 24" FROM THE EDGE OF THE DECK LEDGER BOARD.

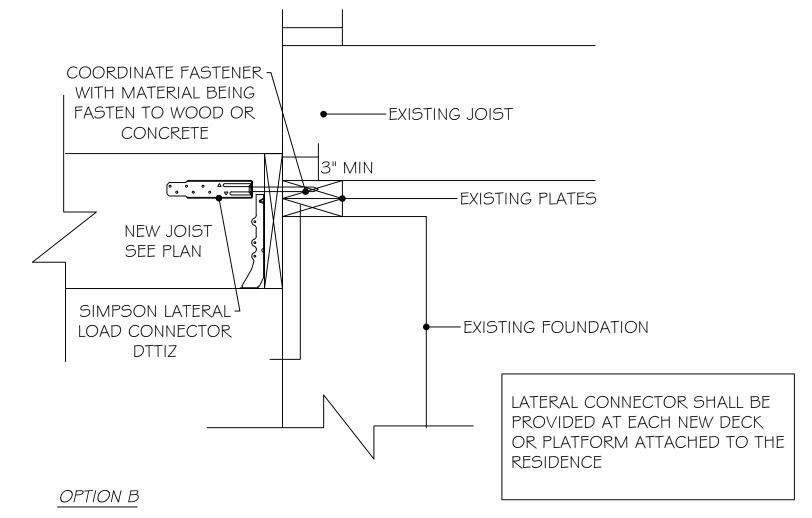


PROVIDE 4 CONNECTOR PER LEDGER EVENLY SPACED AND INSTALLED WITHIN 24" FROM THE EDGE OF THE DECK LEDGER BOARD.

DECK LEDGER BOARD.

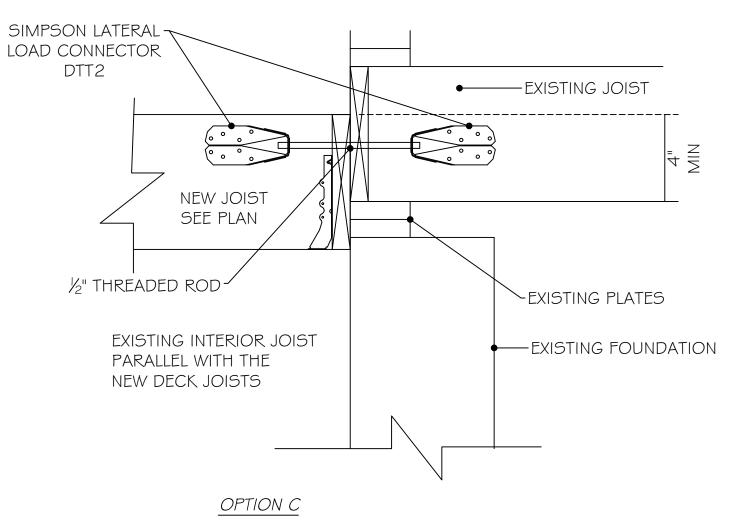


PROVIDE 4 CONNECTOR PER LEDGER EVENLY SPACED AND INSTALLED WITHIN 24" FROM THE EDGE OF THE DECK LEDGER BOARD.

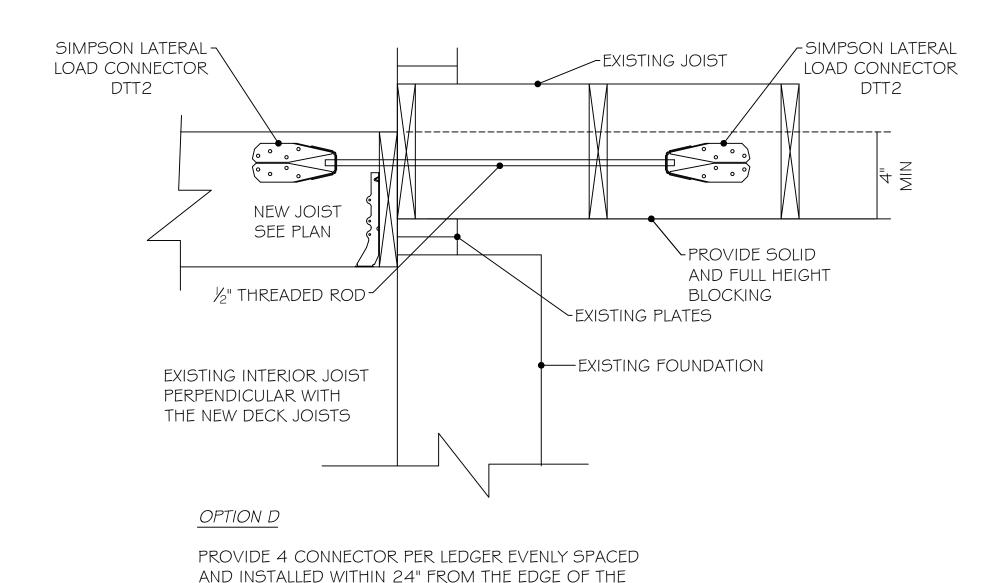


LATERAL BRACING DETAILS

SCALE: 1/4" = 1'0"

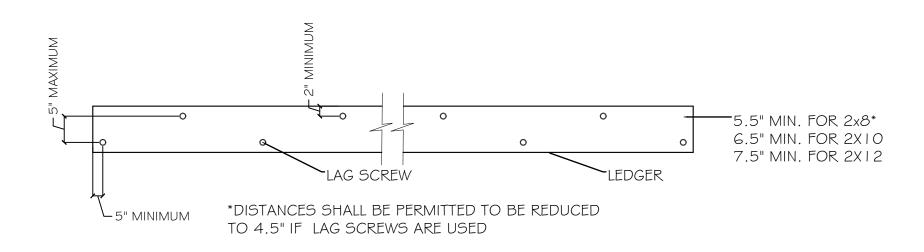


FASTENING PATTERN FOR LEDGER BOARDS (TYP.)


SCALE: 1/4" = 1'0"

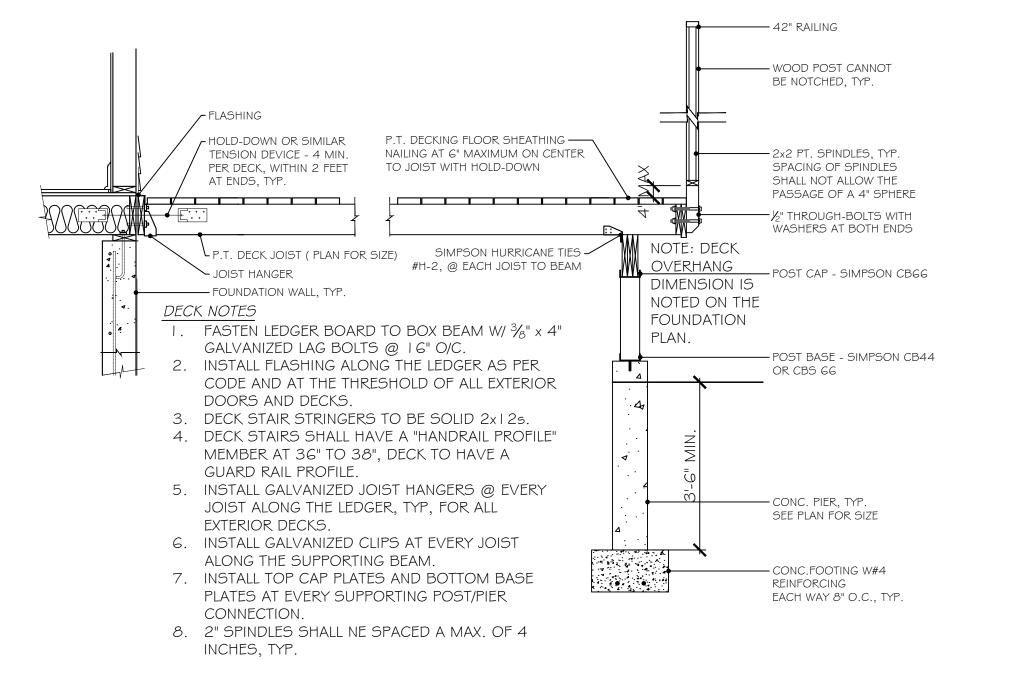



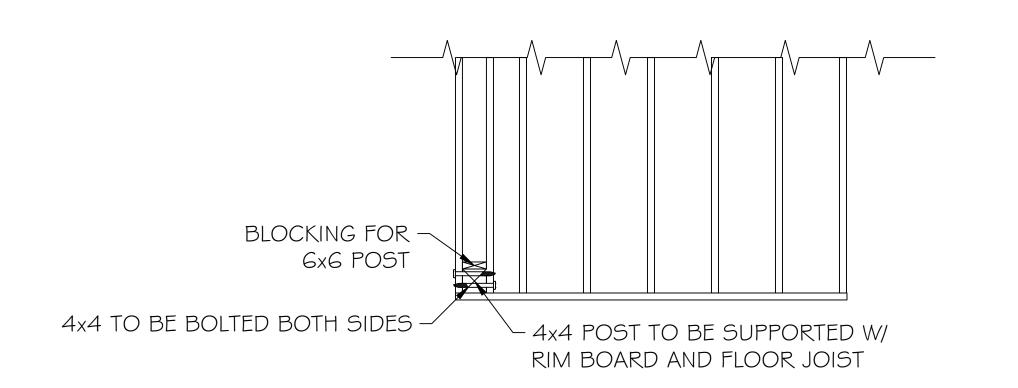

RAILING POST SUPPORT DETAIL (TYP.) SCALE: 1/4" = 1'0"

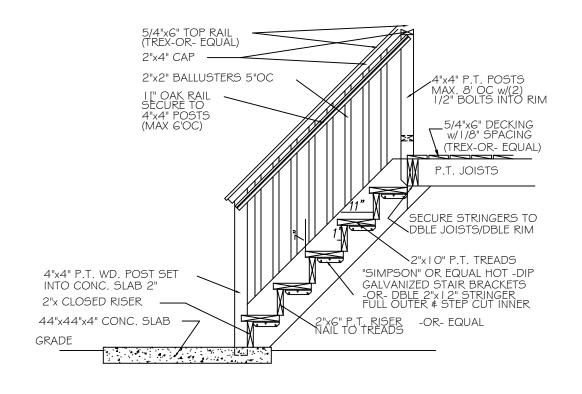

EXTERIOR PRES. TRTD. STAIR DETAIL

SCALE: 1/4" = 1'0"



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Proposed New Addition For:

[7] Sterling Forest Ln.

Montebello


Rockland County, New York

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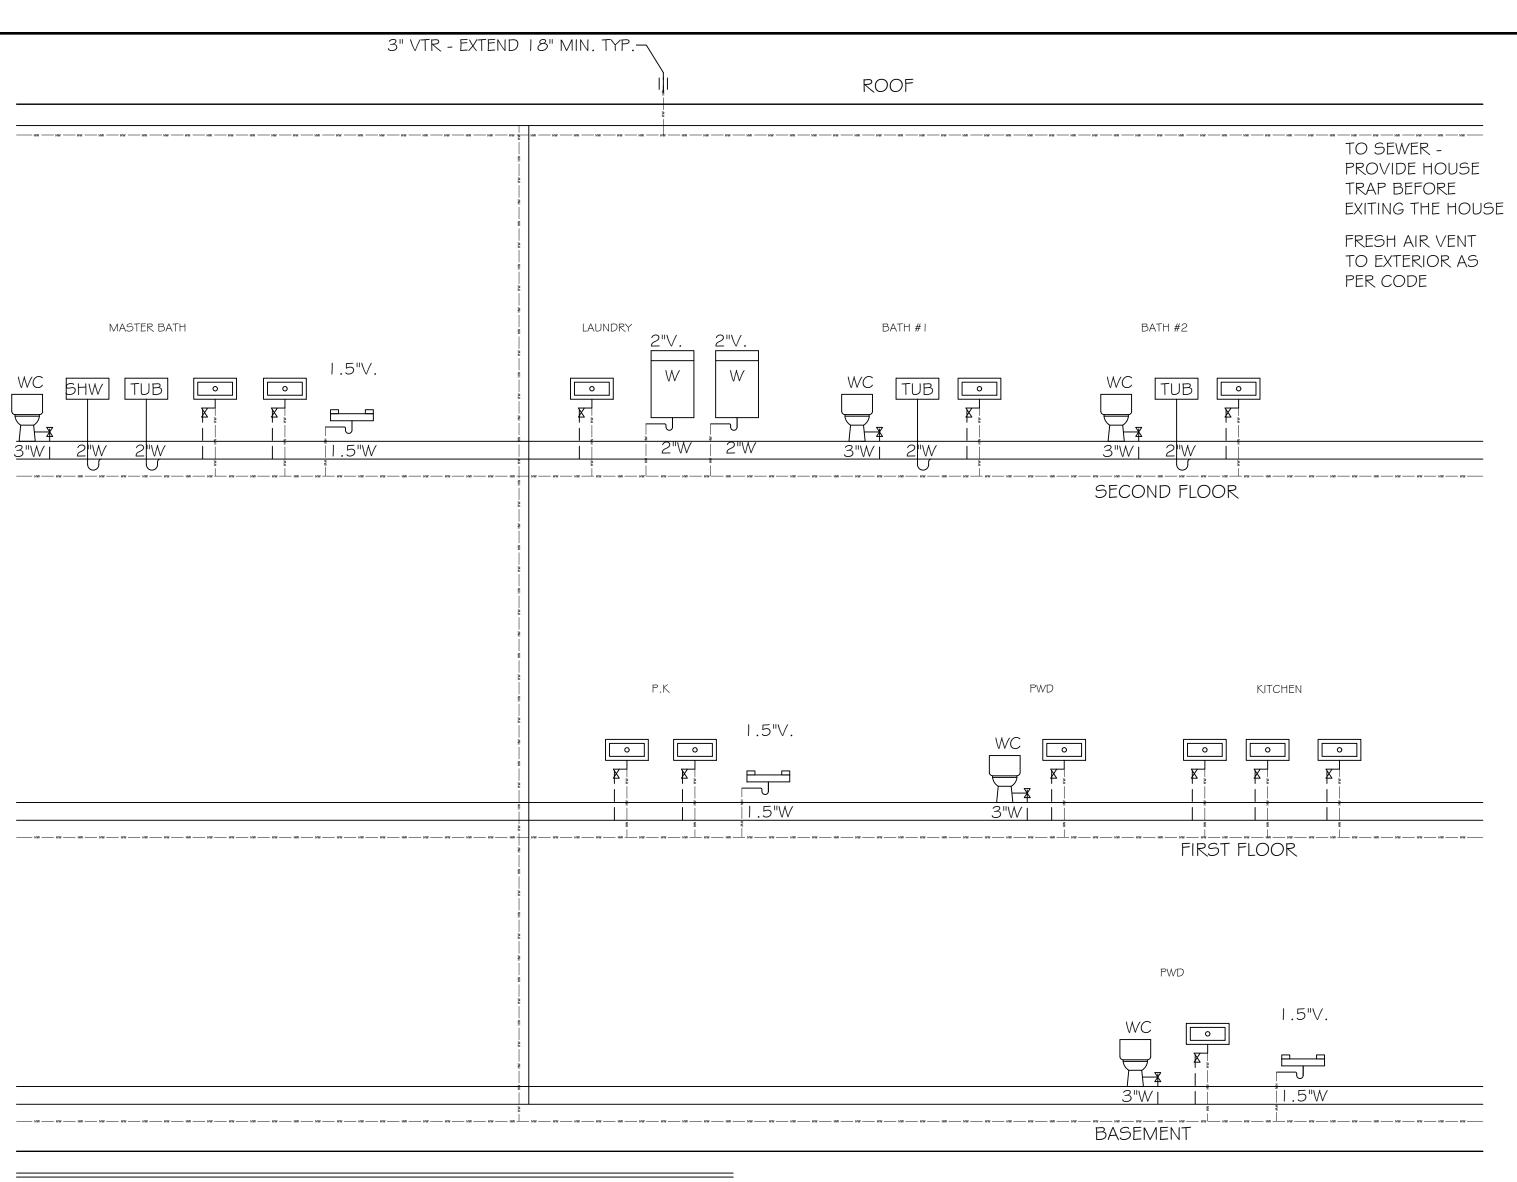
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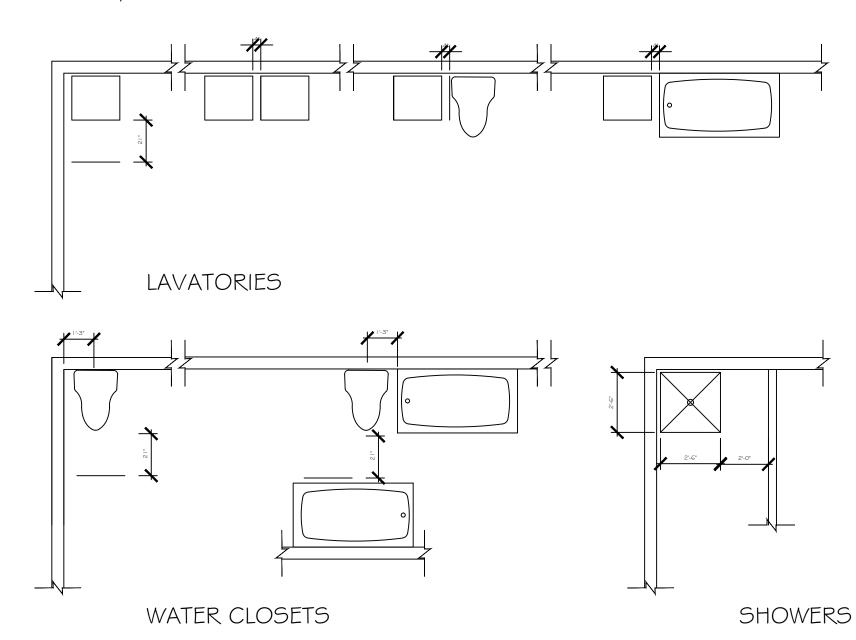
DESCRIPTION:

A-107



 $4"W - SLOPE \frac{1}{4}" PER FOOT MIN.$

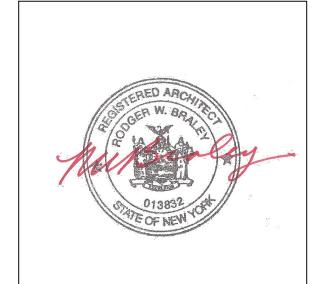



MINIMUM PLUMBING FIXTURE CLEARANCES SCALE: 1/4" = 1'0"

BUILDING TO COMPLY WITH THE 2020 ENERGY CONSERVATION CONSTRUCTION CODE OF NEW YORK STATE (ECCCNYS). SECTION R401.3 CERTIFICATE

A PERMANENT CERTIFICATE SHALL BE COMPLETED BY THE BUILDER OR REGISTERED DESIGN PROFESSIONAL AND POSTED ON A WALL IN THE SPACE WHERE THE FURNACE IS LOCATED, A UTILITY ROOM OR AN APPROVED LOCATION INSIDE THE BUILDING. WHERE LOCATED ON AN ELECTRICAL PANEL, THE CERTIFICATE SHALL NOT COVER OR OBSTRUCT THE VISIBILITY OF THE CIRCUIT DIRECTORY LABEL, SERVICE DISCONNECT LABEL OR OTHER REQUIRED LABELS. THE CERTIFICATE SHALL LIST THE PREDOMINANT R-VALUES OF INSULATION INSTALLED IN OR ON CEILING/ROOF. WALLS, FOUNDATION (SLAB, BASEMENT WALL, CRAWLSPACE WALL AND FLOOR) AND DUCTS OUTSIDE CONDITIONED SPACES; U-FACTORS FOR FENESTRATION AND THE SOLAR HEAT GAIN COEFFICIENT (SHCC) OF FENESTRATION, AND THE RESULTS FROM ANY REQUIRED DUCT SYSTEM AND BUILDING ENVELOPE AIR LEAKAGE TESTING DONE ON THE BUILDING. WHERE THERE IS MORE THAN ONE VALUE FOR EACH COMPONENT, THE CERTIFICATE SHALL LIST THE VALUE COVERING THE LARGEST AREA. THE CERTIFICATE SHALL LIST THE TYPES AND EFFICIENCIES OF HEATING, COOLING AND SERVICE WATER HEATING EQUIPMENT. WHERE A GAS-FIRED UNVENTED ROOM HEATER, ELECTRIC FURNACE OR BASEBOARD ELECTRIC HEATER IS INSTALLED IN THE RESIDENCE. THE CERTIFICATE SHALL LIST "GAS-FIRED UNVENTED ROOM HEATER," 'ELECTRIC FURNACE" OR 'BASEBOARD ELECTRIC HEATER," AS APPROPRIATE. AN EFFICIENCY SHALL NOT BE LISTED FOR GAS-FIRED UNVENTED ROOM HEATERS, ELECTRIC FURNACES OR ELECTRIC BASEBOARD

TO THE BEST OF MY KNOWLEDGE, BELIEF AND PROFESSIONAL JUDGMENT, THESE PLANS AND SPECIFICATIONS ARE IN COMPLIANCE WITH THE ENERGY CONSERVATION CONSTRUCTION CODE OF NEW YORK STATE.

SECTION 402 BUILDING THERMAL ENVELOPE ALL VALUES INDICATED ARE THE PRESCRIPTIVE METHOD FOR CLIMATE ZONE 5. IF A RESCHECK IS PROVIDED WITH SUBSTITUTED VALUES, THAN THE RESCHECK SHALL BE FOLLOWED.

ALL R-VALUES ARE ACCORDING TO TABLE R402.1.2, AND U-FACTOR VALUES ARE ACCORDING TO TABLE R402.1.4. CEILING TO HAVE R-49 INSULATION R-38 SHALL BE DEEMED TO SATISFY THE REQUIREMENT FOR

R-49 WHEREVER THE FULL HEIGHT OF UNCOMPRESSED R-38 INSULATION EXTENDS OVER THE WALL TOP PLATE AT THE EAVES (100% OF THE CEILING AREA) WOOD FRAMED WALLS OF BUILDING TO HAVE R-20 CAVITY

INSULATION OR R-13 CAVITY INSULATION + R-5 CONTINUES INSULATION MASS WALLS ABOVE GROUND (IF APPLICABLE) TO HAVE R-13 INSULATION OR R-17 IF MORE THAN HALF OF THE INSULATION IS

ON THE INTERIOR OF THE MASS WALL BASEMENT WALLS SHALL HAVE MINIMUM OF R-15 CONTINUOUS INSULATION ON THE INTERIOR OR EXTERIOR OF THE BASEMENT

WALL. OR A MINIMUM OF R-19 CAVITY INSULATION AT THE INTERIOR OF THE BASEMENT WALL.

BASEMENT WALLS ASSOCIATED WITH CONDITIONED BASEMENTS SHALL BE INSULATED FROM THE TOP OF THE BASEMENT WALL DOWN TO 10 FEET BELOW GRADE OR TO THE BASEMENT FLOOR. WHICHEVER IS LESS. WALLS ASSOCIATED WITH UNCONDITIONED BASEMENTS SHALL MEET THIS REQUIREMENT UNLESS THE FLOOR OVERHEAD IS INSULATED

FLOORS TO HAVE R-30 INSULATION OR INSULATION SUFFICIENT TO FILL THE FRAMING CAVITY, R-19 MINIMUM FENESTRATION OF BUILDING TO HAVE A U-FACTOR OF 0.30

(EXCLUDING SKYLIGHTS). SLAB ON GRADE (IF APPLICABLE) TO HAVE R-10 INSULATION FOR A DEPTH OF 2 FEET.

SLAB-ON-GRADE FLOORS WITH A FLOOR SURFACE LESS THAN 12 INCHES (305 MM) BELOW GRADE SHALL BE INSULATED WITH R-10 INSULATION. THE INSULATION SHALL EXTEND DOWNWARD FROM THE TOP OF THE SLAB ON THE OUTSIDE OR INSIDE OF THE FOUNDATION WALL. INSULATION LOCATED BELOW GRADE SHALL BE EXTENDED 2'-O" BY ANY COMBINATION OF VERTICAL INSULATION,

CRAWL SPACE SHALL HAVE MINIMUM R-15 OF CONTINUOUS INSULATION ON THE INTERIOR OR EXTERIOR OF THE WALL OR MINIMUM OF R-19 OF CAVITY INSULATION AT THE INTERIOR OF THE BASEMENT WALL.

SKYLIGHTS TO HAVE A U FACTOR OF 0.55. MAXIMUM FENESTRATION U-FACTOR AND SHGC THE AREA-WEIGHTED AVERAGE MAXIMUM FENESTRATION U-FACTOR PERMITTED USING TRADEOFFS FROM SECTION R402.1.5 OR R405 SHALL BE 0.48, FOR VERTICAL FENESTRATION, AND 0.75 FOR SKYLIGHTS

FIRE SEPARATION WALLS BETWEEN WELLING UNITS IN TWO-FAMILY DWELLINGS AND MULTIPLE SINGLE-FAMILY DWELLINGS (TOWNHOUSES) SHALL BE INSULATED TO NO LESS THAN R-10 AND THE WALLS SHALL BE AIR SEALED IN ACCORDANCE WITH SECTION 402.4

THE BUILDING THERMAL ENVELOPE SHALL BE CONSTRUCTED TO LIMIT AIR LEAKAGE. THE SEALING METHODS BETWEEN DISSIMILAR MATERIALS SHALL ALLOW FOR DIFFERENTIAL EXPANSION AND CONTRACTION. THE COMPONENTS OF THE BUILDING THERMAL ENVELOPE SHALL

COMPLY WITH TABLE R402.4.1.1 OF THE 2020 ECCCNYS AND SHALL BE INSTALLED IN ACCORDANCE WITH THE MANUFACTURER'S INSTRUCTIONS AND THE CRITERIA INDICATED IN TABLE R402.4.1.1, AS APPLICABLE TO THE METHOD OF

CONSTRUCTION.

WINDOWS. SKYLIGHTS AND SLIDING GLASS DOORS SHALL HAVE AN AIR INFILTRATION RATE OF NO MORE THAN 0.3 CM PER SQUARE FOOT (1.5 L/S/M2), AND SWINGING DOORS NO MORE THAN 0.5 CM PER SQUARE FOQT (2.6 L/S/M2), WHEN TESTED ACCORDING TO NFRC 400 OR AAMA/WDMA/CSA 101/ I.S.2/A440 BY AN ACCREDITED, INDEPENDENT LABORATORY AND LISTED AND LABELED BY THE MANUFACTURER

VAPOR BARRIER TO BE ON HEATED OR LIVING SIDE IN FLOORS. WALLS AND CEILING (WHERE APPLICABLE) FIBERGLASS SILL PLATE INSULATION TO BE USED UNDER ALL SILL PLATES, WHETHER ON CRAWL SPACE WALLS OR SLABS. TESTING BUILDING ENVELOPE SHALL BE TESTED ACCORDING TO SECTION R402.4.1.2

THE BUILDING OR DWELLING UNIT SHALL BE TESTED AND VERIFIED AS HAVING AN AIR LEAKAGE RATE NOT EXCEEDING THREE AIR CHANGES PER HOUR IN CLIMATE ZONES 3 THROUGH 8. TESTING SHALL BE CONDUCTED IN ACCORDANCE WITH ASTM E 779 OR ASTM E 1827 AND REPORTED AT A PRESSURE OF 0.2 INCH W.G. (50 PASCALS). TESTING SHALL BE PERFORMED AT ANY TIME AFTER CREATION OF ALL

SECTION R403 SYSTEMS

BUILDING MECHANICAL SYSTEMS SHALL COMPLY WITH SECTION R403 OF THE ENERGY CONSERVATION CONSTRUCTION CODE OF NEW YORK STATE (ECCCNYS)

EACH UNIT TO HAVE AT LEAST ONE PROGRAMMABLE THERMOSTAT FOR EACH SEPARATE HEATING AND COOLING CONTROLLING THE PRIMARY HEATING OR COOLING SYSTEM OF THE DWELLING UNIT SHALL BE CAPABLE OF CONTROLLING THE HEATING AND COOLING SYSTEM ON A DAILY SCHEDULE TO MAINTAIN DIFFERENT TEMPERATURE SET POINTS AT DIFFERENT TIMES OF THE DAY. THIS THERMOSTAT SHALL INCLUDE THE CAPABILITY TO SET BACK OR TEMPORARILY OPERATE THE SYSTEM TO MAINTAIN ZONE TEMPERATURES DOWN TO 55°F (13°C) OR UP TO 85°F (29°C). THE THERMOSTAT SHALL INITIALLY BE PROGRAMMED BY THE MANUFACTURER WITH A HEATING TEMPERATURE SET POINT NO HIGHER THAN 70°F (21°C) AND A COOLING TEMPERATURE SET POINT NO LOWER THAN 78°F (26°C). HEAT PUMPS HAVING SUPPLEMENTARY ELECTRIC-RESISTANCE HEAT SHALL HAVE CONTROLS THAT. EXCEPT DURING DEFROST. PREVENT SUPPLEMENTAL HEAT OPERATION WHEN THE HEAT PUMP COMPRESSOR CAN MEET THE HEATING LOAD. ALL SUPPLY AND RETURN DUCTS IN ATTICS SHALL BE INSULATED TO A MINIMUM OF R-8 WHERE 3 INCHES IN DIAMETER AND GREATER AND R-6 WHERE LESS THAN 3 INCHES IN DIAMETER. SUPPLY AND RETURN DUCTS IN OTHER PORTIONS OF THE BUILDING SHALL BE INSULATED TO A MINIMUM OF R-6 WHERE 3 INCHES IN DIAMETER OR GREATER AND R-4.2 WHERE LESS THAN 3 INCHES IN DIAMETER.

EXCEPTION: DUCTS OR PORTIONS THEREOF LOCATED COMPLETELY INSIDE THE BUILDING THERMAL ENVELOPE. SEALING: DUCTS. AIR HANDLERS AND FILTER BOXES SHALL BE SEALED. JOINTS AND SEAMS SHALL COMPLY WITH EITHER THE INTERNATIONAL MECHANICAL CODE OR INTERNATIONAL RESIDENTIAL CODE, AS APPLICABLE. **EXCEPTIONS:**

ALLR.-IMPERMEABLE SPRAY FOAM PRODUCTS SHALL BE PERMITTED 10 BE APPLIED WITHOUT ADDITIONAL JOINT

2F.OR DUCTS HAVING A STATIC PRESSURE CLASSIFICATION OF LESS THAN 2 INCHES OF WATER COLUMN (500 PA). ADDITIONAL CLOSURE SYSTEMS SHALL NOT BE REQUIRED FOR CONTINUOUSLY WELDED JOINTS AND SEAMS. AND LOCKING-TYPE JOINTS AND SEAMS OF OTHER THAN THE SNAP-LOCK AND BUTTON-LOCK TYPES. ALL DUCTS TO BE TESTED FOR LEAKAGE ACCORDING TO

SECTION R403.3.3 OF THE ENERGY CONSERVATION CONSTRUCTION CODE OF NEW YORK STATE (ECCCNYS) BUILDING FRAMING CAVITIES SHALL NOT BE USED AS DUCTS OR PLENUMS

ALL DUCTS TO COMPLY WITH SECTION R403.3 OF THE ENERGY CONSERVATION CONSTRUCTION CODE OF NEW YORK STATE ALL MECHANICAL SYSTEM PIPING INSULATION TO COMPLY WITH

SECTION R403.4 OF THE ENERGY CONSERVATION CONSTRUCTION CODE OF NEW YORK STATE (ECCCNYS) SERVICE HOT WATER SYSTEMS TO COMPLY WITH SECTION R403.5 OF THE ENERGY CONSERVATION CONSTRUCTION CODE

OF NEW YORK STATE (ECCCNYS) HEATED WATER CIRCULATION SYSTEMS SHALL BE IN ACCORDANCE WITH SECTION R403.5.1.1. HEAT TRACE TEMPERATURE MAINTENANCE SYSTEMS SHALL BE IN ACCORDANCE WITH SECTION R403.5.1.2. AUTOMATIC CONTROLS, TEMPERATURE SENSORS AND PUMPS SHALL BE ACCESSIBLE.

MANUAL CONTROLS SHALL BE READILY ACCESSIBLE.

R403.5.1.1 CIRCULATION SYSTEMS. HEATED WATER CIRCULATION SYSTEMS SHALL BE PROVIDED WITH A CIRCULATION PUMP. THE SYSTEM RETURN PIPE SHALL BE A DEDICATED RETURN PIPE OR A COLD WATER SUPPLY PIPE. GRAVITY AND THERMOSYPHON CIRCULATION SYSTEMS SHALL BE PROHIBITED. CONTROLS FOR CIRCULATING HOT WATER SYSTEM PUMPS SHALL START THE PUMP BASED ON THE IDENTIFICATION OF A DEMAND FOR HOT WATER WITHIN THE OCCUPANCY. THE CONTROLS SHALL AUTOMATICALLY TURN OF THE PUMP WHEN THE WATER IN THE CIRCULATION LOOP IS AT THE DESIRED TEMPERATURE AND WHEN THERE IS NO DEMAND FOR HOT

WATER. R403.5.1.2 HEAT TRACE SYSTEMS. ELECTRIC HEAT TRACE SYSTEMS SHALL COMPLY WITH IEEE 5 | 5.1 OR UL 515. CONTROLS FOR SUCH SYSTEMS SHALL AUTOMATICALLY ADJUST THE ENERGY INPUT TO THE HEAT TRACING TO MAINTAIN THE DESIRED WATER TEMPERATURE IN THE PIPING IN ACCORDANCE WITH THE TIMES WHEN HEATED WATER IS USED IN THE OCCUPANCY

MECHANICAL VENTILATION TO COMPLY WITH SECTION R403.6 OF THE ENERGY CONSERVATION CONSTRUCTION CODE OF NEW YORK STATE (ECCCNYS)

R403.7 EQUIPMENT SIZING AND EFFICIENCY RATING. HEATING AND COOLING EQUIPMENT SHALL BE SIZED IN ACCORDANCE WITH ACCA MANUAL S BASED ON BUILDING LOADS CALCULATED IN ACCORDANCE WITH ACCA MANUAL J OR OTHER APPROVED HEATING AND COOLING CALCULATION METHODOLOGIES. NEW OR REPLACEMENT HEATING AND COOLING EQUIPMENT SHALL HAVE AN EFFICIENCY RATING EQUAL TO OR GREATER THAN THE MINIMUM REQUIRED BY FEDERAL LAW FOR THE GEOGRAPHIC LOCATION WHERE THE EQUIPMENT IS INSTALLED.

R403.8 SYSTEMS SERVING MULTIPLE DWELLING UNITS. SYSTEMS SERVING MULTIPLE DWELLING UNITS SHALL COMPLY WITH SECTIONS C403 AND C404 OF THE ECCCNYS -COMMERCIAL PROVISIONS IN LIEU OF SECTION R403 R403.9 SNOW MELT AND ICE SYSTEM CONTROLS. SNOW- AND ICE-MELTING SYSTEMS, SUPPLIED THROUGH ENERGY SERVICE TO THE BUILDING, SHALL INCLUDE AUTOMATIC CONTROLS CAPABLE OF SHUTTING OFF THE SYSTEM WHEN THE PAVEMENT TEMPERATURE IS ABOVE 50F (10°C), AND NO PRECIPITATION IS FALLING AND AN AUTOMATIC OR MANUAL CONTROL THAT WILL ALLOW SHUTOFF WHEN THE OUTDOOR TEMPERATURE IS ABOVE 40°F (4.8°C). SECTION R404 ELECTRICAL POWER AND LIGHTING SYSTEMS A MINIMUM OF 90 PERCENT OF THE LAMPS IN PERMANENTLY INSTALLED LIGHTING FIXTURES SHALL BE HIGH-EFFICACY LAMPS. FUEL GAS SYSTEMS SHALL NOT HAVE CONTINUOUSLY BURNING

PILOT LIGHTS. IN ALL BUILDINGS HAVING INDIVIDUAL DWELLING UNITS, PROVISIONS SHALL BE MADE TO DETERMINE THE ELECTRICAL ENERGY CONSUMED BY EACH UNIT BY SEPARATELY METERING OR MONITORING INDIVIDUAL DWELLING UNITS.



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PROJECT:

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DRAWN BY:	Shlome Glauber
DATE:	7/15/2024
DATE:	8/2/2024
DATE:	8/28/2024
DATE:	1/13/2025
DATE:	3/10/2025

RODGER BRADLEY ARCHITECTS NYS LIC. NO. 013-832 50 PLATTS HILL ROAD NEWTOWN, CT 06470


Email: rbraley2@sbcglobal.net

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DESCRIPTION:

PL-01



BASEMENT FLOOR ELECTRIC PLAN SCALE: 1/4" = 1'0"

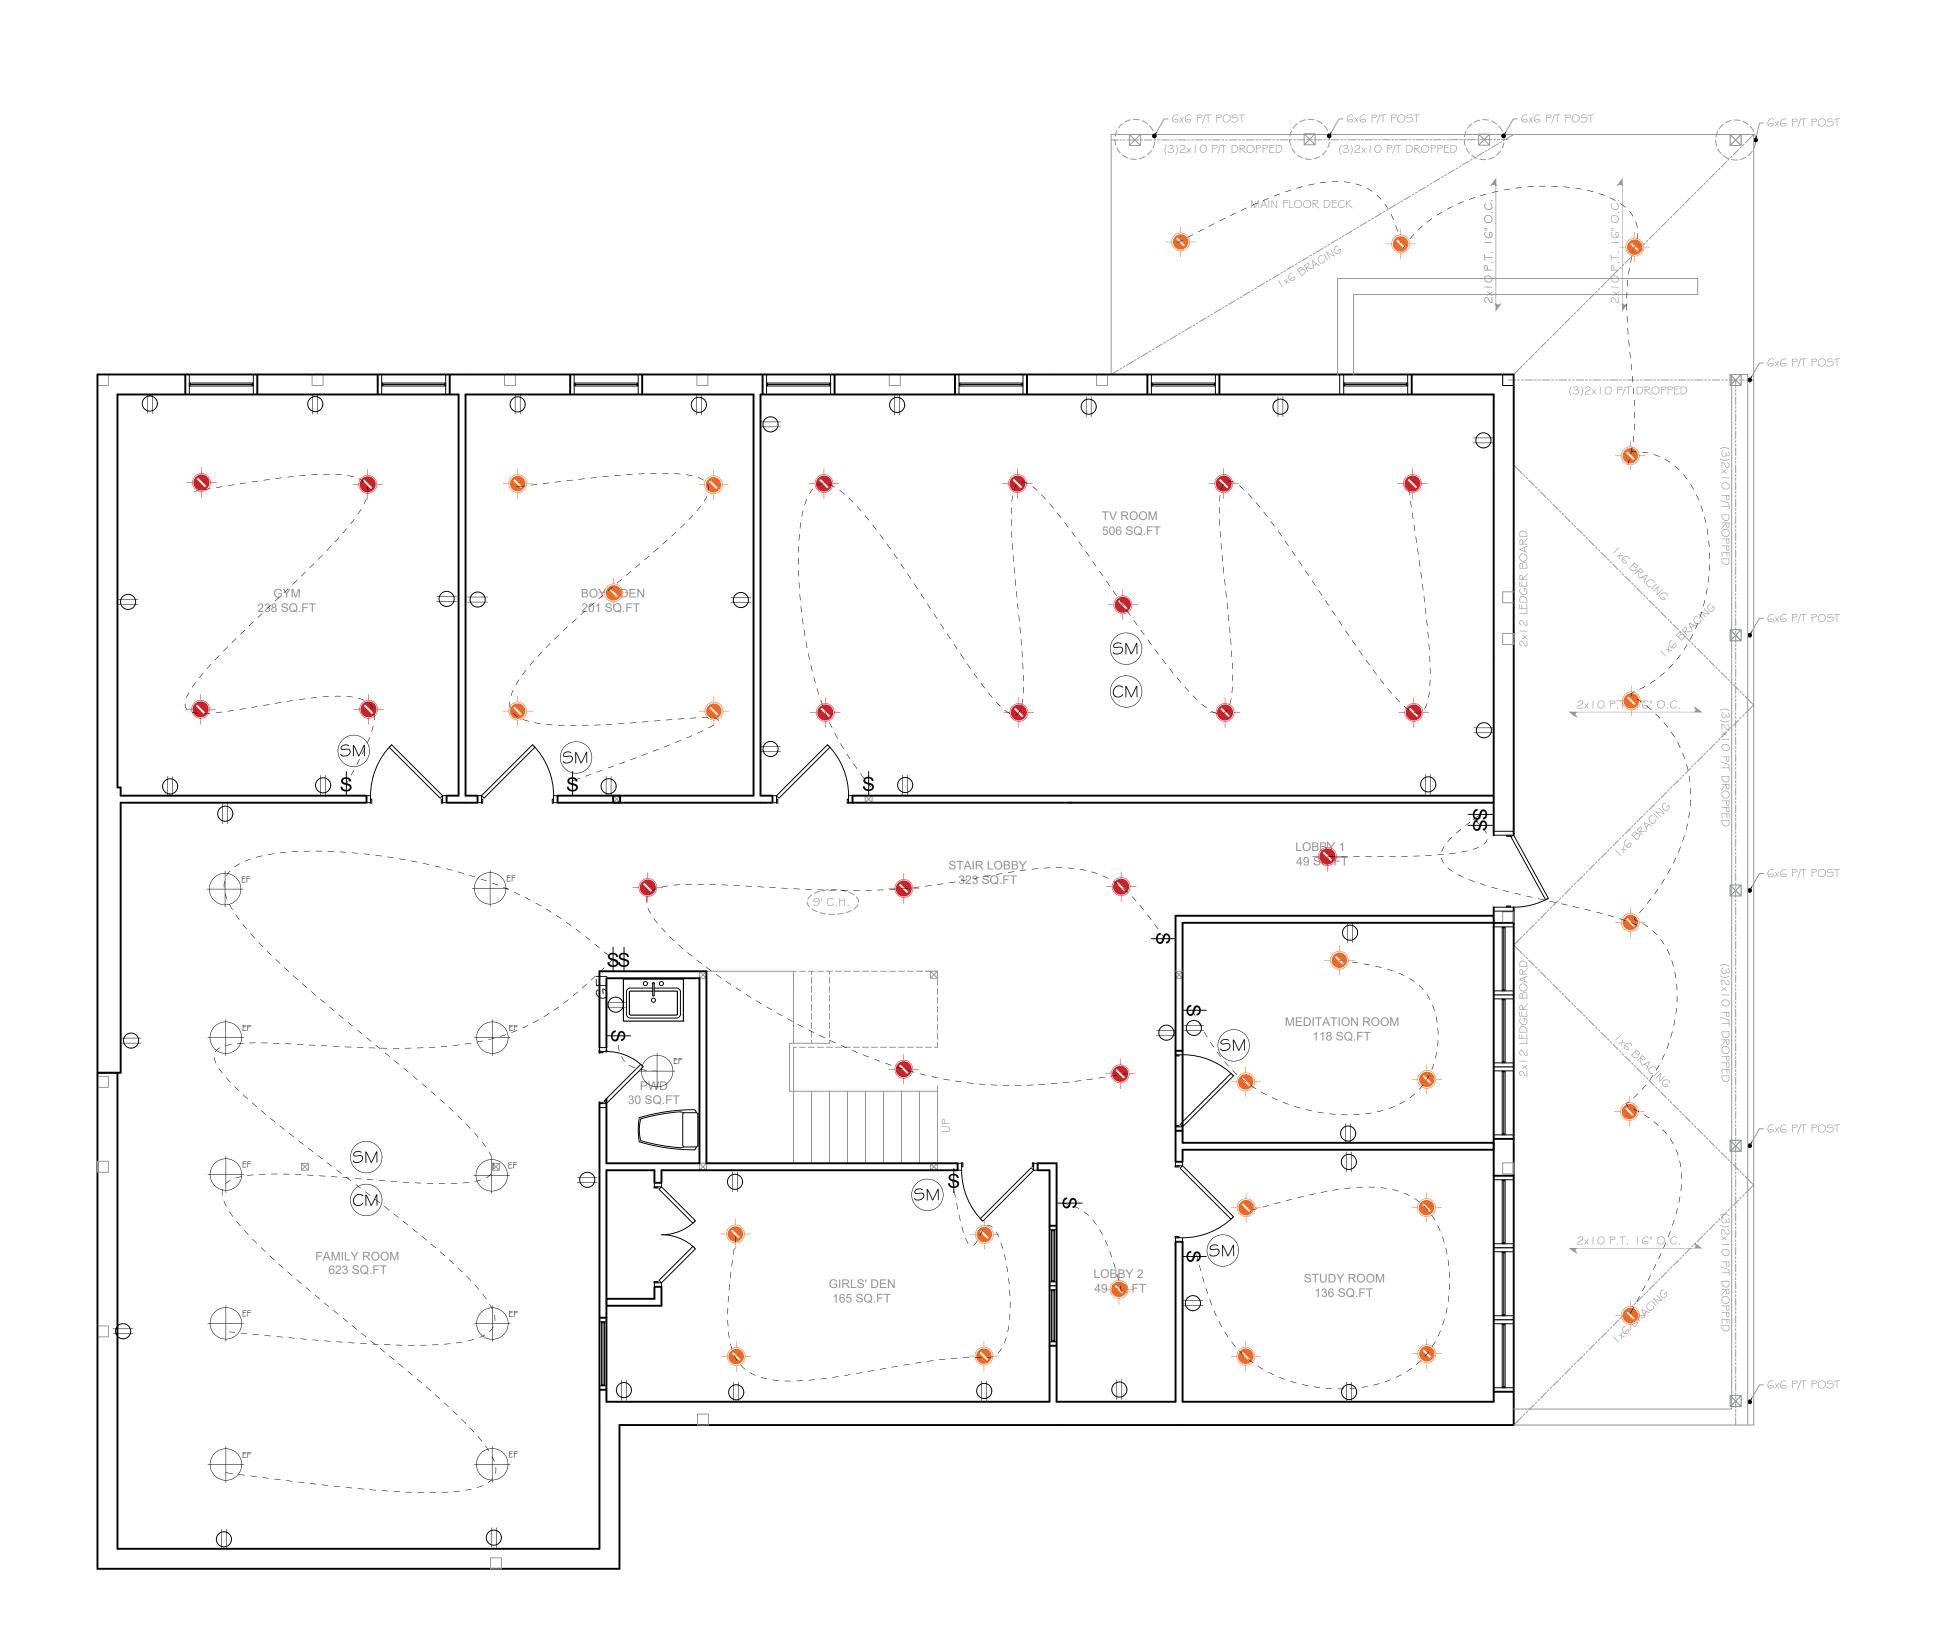ELECTRICAL SYMBOLS LEGEND

- A 12 WATT LED BULB OR EQUIVALENT
- A 8 WATT LED BULB OR EQUIVALENT
- A 20 WATT LED BULB OR EQUIVALENT

COMBINATION EXHAUST FAN / LIGHT (8W LED) - DIRECTLY

TO EXTERIOR, MIN, 48" FROM WINDOW OR OPENING DUPLEX RECEPTACLE OUTLET

GROUND FAULT PROTECTION RECEPTACLE OR CIRCUIT

LIGHT SWITCH

SMOKE DETECTOR INTERCONNECTED

CARBON MONOXIDE DETECTOR INTERCONNECTED

LED Wattage Calculation (for Ambient Lighting)
Assuming 20 lumens/sq. ft. for ambient lighting and 100 lumens/watt for LED lights:

		12W BUIB	8W BULB		TOTA 3 WATT
GYM	(238sq. ft.×20)÷100=47.6	4	0	0	48
BOYS' DEN	$(201sq. ft. \times 20) \div 100 = 40.2$	0	5	0	40
TV ROOM	(506sq. ft.×20)÷100=101.2	9	0	0	108
MEDITATION ROOM	$(118sq. ft. \times 20) \div 100 = 23.6$	0	3	0	24
STUDY ROOM	(136sq. ft.×20)÷100= 27.2	0	4	0	32
FAMILY ROOM	(623sq. ft.×20)÷100=124.6	0	0	10	120
STAIR LOBBY	$(323sq. ft. \times 20) \div 100 = 64.6$	5	0	0	60
LOBBY I	(62sq. ft.×20)÷100=12.4	1	0	0	12
LOBBY 2	$(49sq. ft. \times 20) \div 100 = 9.8$	0	I	0	8
		12W	20W	12W	TOTA
	(504 sq. ft. × 20) ÷ 100 = 100.8 x 2=201.6		BULB	EF+E	3 WATT
DINING (double height)	$(504 \text{ sq. ft.} \times 20) \div 100 = 100.8 \times 2 = 201.6$	0	10	0	200
LIVING (double height)	,	0		0	210
PLAYROOM	$(166 \text{ sq. ft.} \times 20) \div 100 = 33.2$		0	0	36
KITCHEN	$(397 \text{ sq. ft.} \times 20) \div 100 = 79.4$	7	0	0	84
DINETTE	$(249 \text{ sq. ft.} \times 20) \div 100 = 49.8$	4	0	0	48
OFFICE	$(161 \text{ sq. ft.} \times 20) \div 100 = 32.2$	3	0	0	36
MASTER BED	(255 sq. ft. × 20) ÷ 100 = 51	4	0	0	48
MASTER LOUNGE	$(144 \text{ sq. ft.} \times 20) \div 100 = 28.8$	3	0	0	36
BEDROOM 2	$(84 \text{ sq. ft.} \times 20) \div 100 = 16.8$	2	0	0	24
BEDROOM 3	$(104 \text{ sq. ft.} \times 20) \div 100 = 20.8$	2	0	0	24
BEDROOM 4	$(123 \text{ sq. ft.} \times 20) \div 100 = 24.6$	_	0	0	24
BEDROOM 5	$(105 \text{ sq. ft.} \times 20) \div 100 = 21$	2	0	0	24
LAUNDRY	$(50 \text{ sq. ft.} \times 20) \div 100 = 10$		0	0	12

LIGHT AND VENT CALCULATIONS						
ROOM	SF	LIGHT REQUIRED	LIGHT PROVIDED	VENT REQUIRED	VENT PROVIDED	
		BASEMENT				
GYM	238	19.04	10.8	9.52	12.44	
BOYS' DEN	201	16.08	5.4	8.04	6.22	
TV ROOM	506	20.24	45	40.48	49.76	
MEDITATION ROOM	118	4.72	56.25	9.44	61.33	
STUDY ROOM	136	10.88	56.25	5.44	61.33	
FAMILY ROOM	623	49.84	*	24.92	**	
		GROU	ND FLOOR			
DINING/ LIVING/ PLAYROOM	1174	93.9	874	46.9	70.6	
KITCHEN / DINETTE	646	51.7	177.8	25.8	69.8	
OFFICE	161	12.88	52	6.44	53.16	
	•	FIRS	ST FLOOR			
MASTER BEDROOM	255	20.4	111.5	10.2	119	
MASTER LIVING	144	11.52	57	5.76	12.1	
BEDROOM #2	84	6.7	6.83	3.4	7.76	
BEDROOM #3	104	8.3	18.6	4.2	21.1	
BEDROOM #4	123	9.8	18.6	4.9	21.1	
BEDROOM #5	105	8.4	18.6	4.2	21.1	
LAUNDRY	50	4	6.83	2	7.76	



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PROJECT:


Proposed New Addition For:
Sterling Forest I

DRAWN BY:	Shlome Glauber
<u>DATE:</u>	7/15/2024
DATE:	8/2/2024
DATE:	8/28/2024
DATE:	1/13/2025
DATE:	3/10/2025

RODGER BRADLEY, ARCHITECTS NYS LIC. NO. 013-832 50 PLATTS HILL ROAD NEWTOWN, CT 06470


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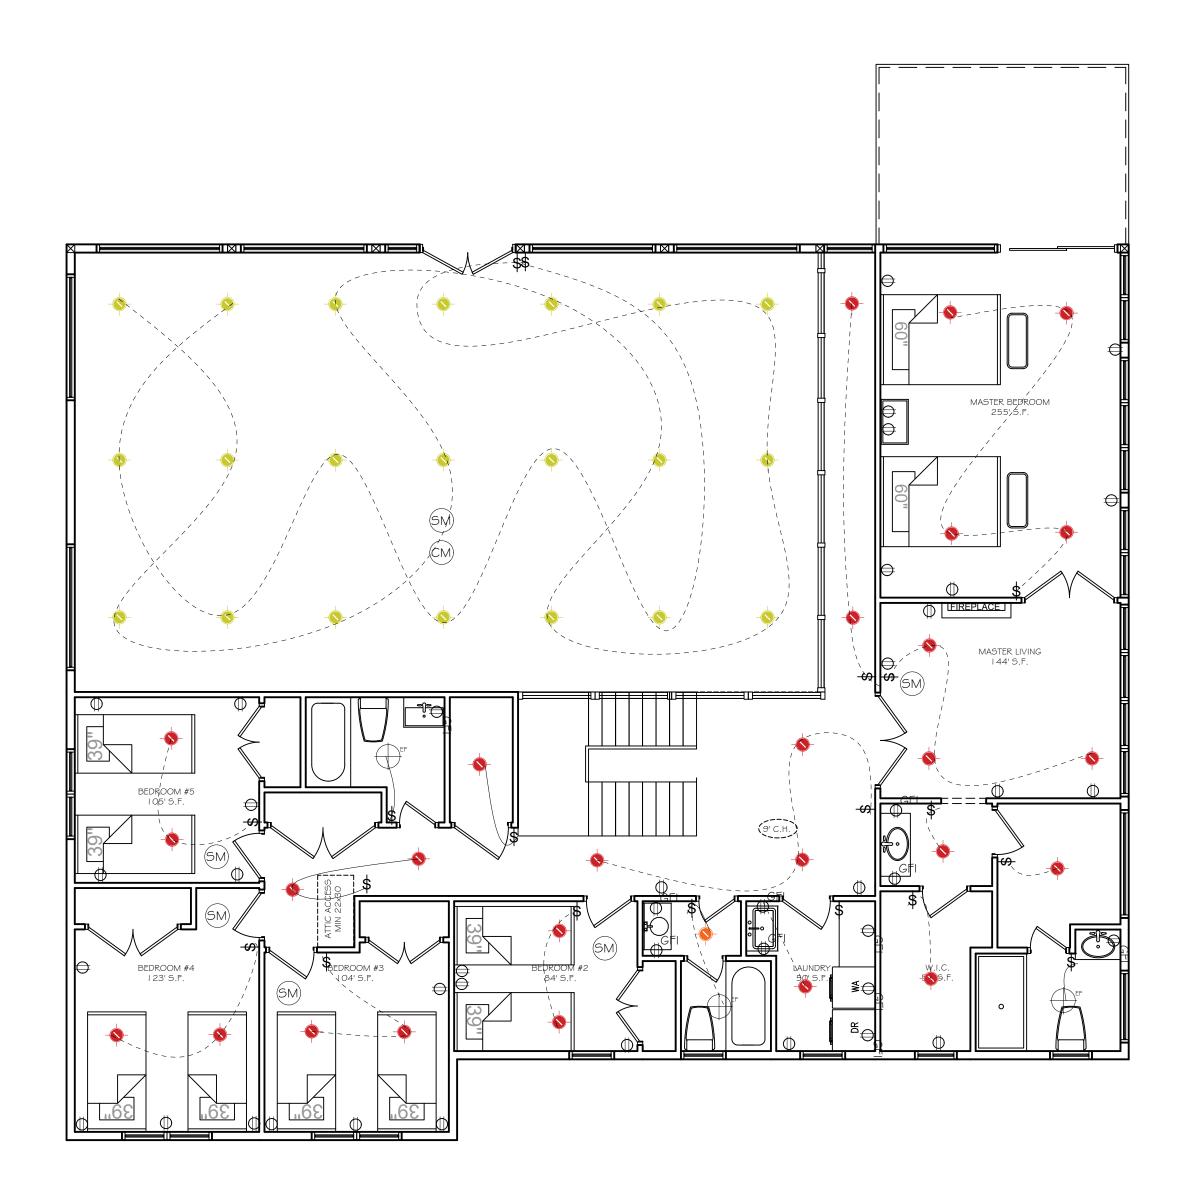


DESCRIPTION:

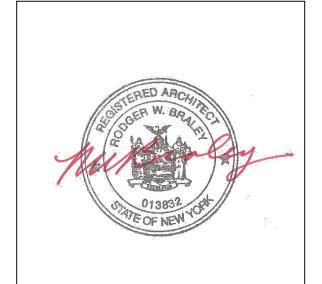E-101





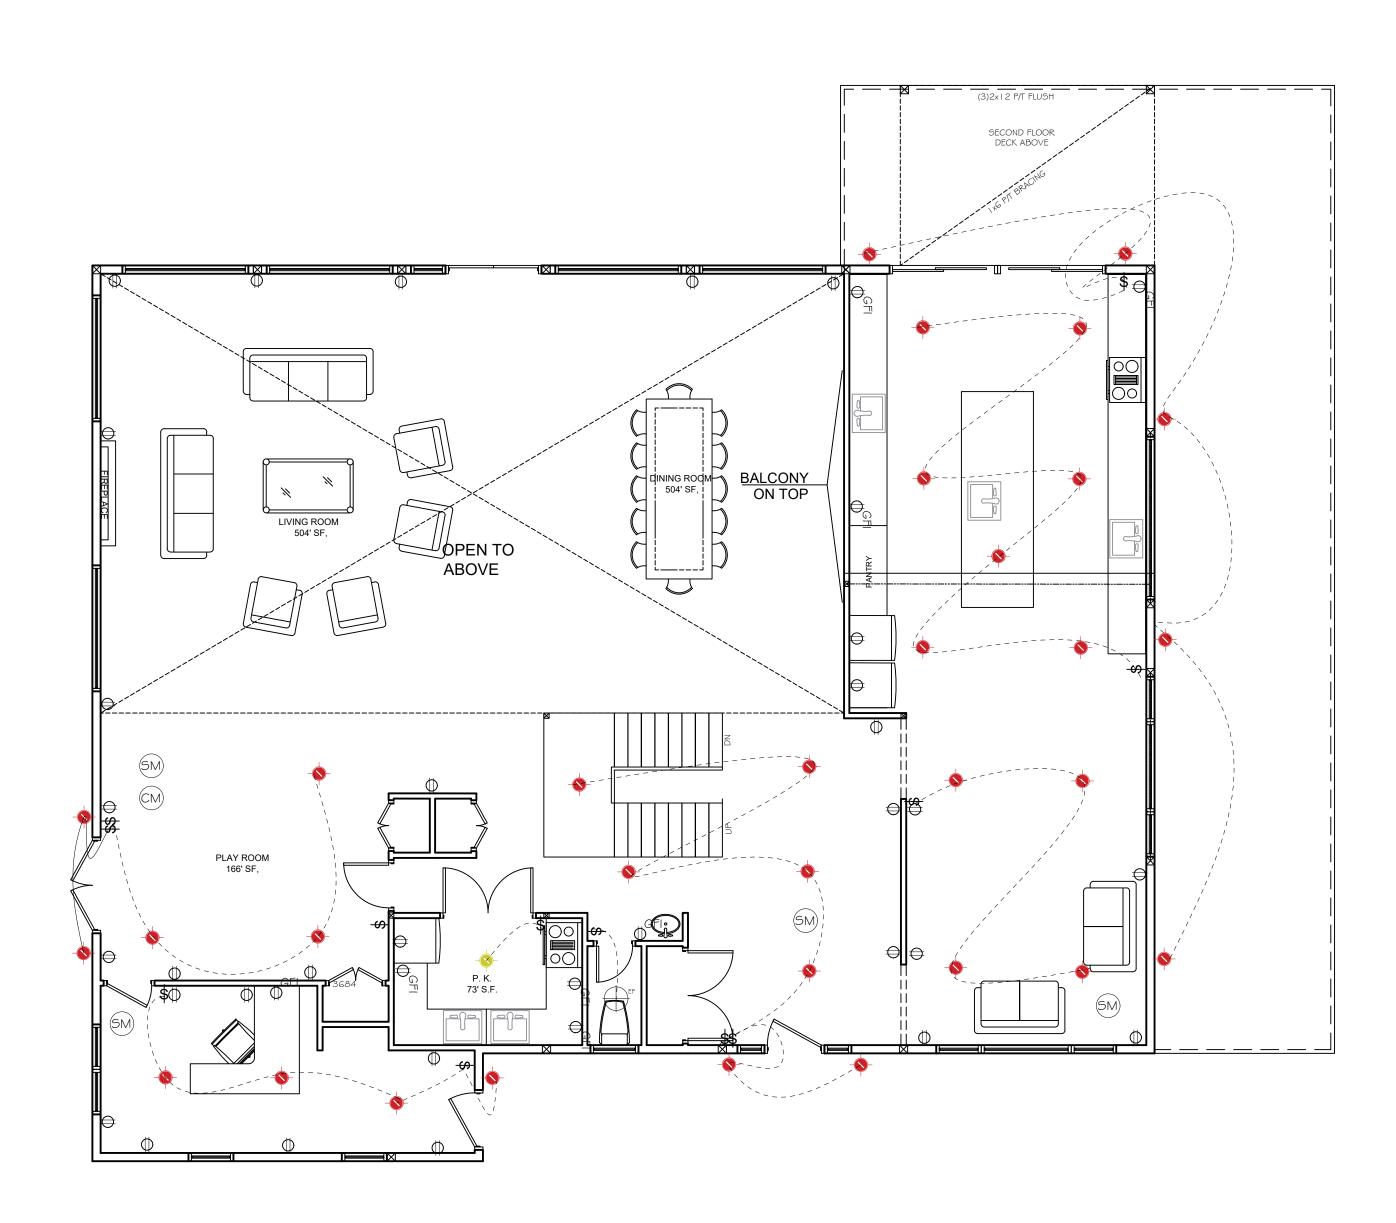

SECOND FLOOR ELECTRIC PLAN

SCALE: 3/16" = 1'0"



MONROE, N.Y. 10950 (845) 492-1783 Email: office@szdrawings.com

PROJECT

Proposed New Addition For:

7 Sterling Forest Lr

Montebello


Rockland County, New Yorl

DRAWN BY:	Shlome Glauber
DATE:	7/15/2024
DATE:	8/2/2024
DATE:	8/28/2024
DATE:	1/13/2025
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RODGER BRADLEY, ARCHITECTS

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DESCRIPTION:

E-102

- ALL WORK SHALL BE IN ACCORDANCE WITH ALL PREVAILING CODES. LAWS AND ORDINANCES OF THE 2020 BUILDING & ENERGY CONSERVATION CODES OF NYS. AND THE LOCAL ZONING LAWS OF WHICH THE PROJECT IS LOCATED.
- THE CONTRACTOR AND ALL SUBCONTRACTORS SHALL CARRY PRIOR. DURING AND AFTER CONSTRUCTION ALL NECESSARY LICENSES AND INSURANCES PER THE N.Y.S., LOCAL AND ALL GOVERNING REGULATIONS.
- THE OWNER SHOULD READ AND REVIEW HIS/HER ENTIRE SET OF CONTRACT DOCUMENTS (PLANS & SPECIFICATIONS) PRIOR TO GIVING IT TO THE CONTRACTOR. OWNER SHALL CONFIRM THAT ALL INFORMATION IS CORRECT. SHOULD THE OWNER FIND ANYTHING THAT WASN'T WHAT THEY INTENDED TO BE DONE, THEN THEY SHALL HAVE THE ARCHITECT AMEND IT AS REQUIRED. THE ARCHITECT IS NOT RESPONSIBLE FOR CONSTRUCTION, AND OR PROJECT SITE. THE GENERAL PUBLIC, PROSPECTIVE BUYERS AND ALL OTHER NON-CONSTRUCTION RELATED PERSONS ARE NOT TO ENTER THE CONSTRUCTION WORK AREA UNTIL A VALID CERTIFICATE OF OCCUPANCY IS
- ISSUED BY THE LOCAL BUILDING DEPARTMENT. THE PROJECT SITE SHALL BE PROPERLY POSTED AND TAPED AND OR FENCED OFF TO ENSURE PUBLIC SAFETY AND SAFEGUARD THE PUBLIC AT ALL TIMES. THE CONTRACTOR SHALL VERIFY ALL DIMENSIONS AND FAMILIARIZE HIMSELF WITH THE CONTRACT DOCUMENTS (PLANS & SPECIFICATIONS) PRIOR TO ANY ERECTION/CONSTRUCTION.
- ALL DIMENSIONS SHALL BE FIELD VERIFIED BY THE CONTRACTOR AND THE CONTRACTOR SHALL REPORT ANY DISCREPANCIES, ERRORS OR OMISSIONS TO THE ARCHITECT IMMEDIATELY. ALWAYS USE DIMENSIONS AS SHOWN AND THE CONTRACTOR SHOULD—REPORT ANY DISCREPANCIES IMMEDIATELY TO THE ARCHITECT.
- DRAWINGS ARE NOT TO BE SCALED. ALL CHANGES MADE BY THE CONTRACTOR SHALL FIRST BE APPROVED BY THE ARCHITECT AND OWNER PRIOR OF STARTING WITH THE WORK INVOLVED. ANY UNAUTHORIZED CHANGES MADE BY THE CONTRACTOR AND ULTIMATELY NOT BEING APPROVED BY THE OWNER AND ARCHITECT SHALL BE THE RESPONSIBILITY OF THE CONTRACTOR AND TO BE CORRECTED AT HIS OWN
- THE ARCHITECT HAS NOT BEEN RETAINED FOR ANY MECHANICAL DESIGN SYSTEMS, DUCTS, CHASE OPENINGS, SIZE OF FURNACE AND FRESH AIR REQUIREMENTS ETC. THESE ARE NOT SHOWN AND SHALL BE DETERMINED BY A MECHANICAL ENGINEER PRIOR OF COMMENCING THE WORK.
- THE ARCHITECT HAS NOT BEEN RETAINED FOR SUPERVISION, AND CONSTRUCTION INSPECTIONS AND/OR THE REVIEW OF SHOP DRAWINGS. THE ARCHITECT HAS ONLY BEEN RETAINED FOR DESIGN PURPOSES. THEREFORE, THE ARCHITECT ASSUMES NO LIABILITY FOR WORKMANSHIP, CODE AND OR PLAN COMPLIANCE. THE ARCHITECTS RESPONSIBILITY IS STRICTLY LIMITED TO THESE PLANS AND
- RELATED SPECIFICATIONS ONLY. THE ARCHITECT SHALL NOT BE RESPONSIBLE FOR ANY CONSTRUCTION MEANS. METHODS, DEVIATIONS, TECHNIQUES, SEQUENCES, OR PROCEDURES, OR FOR ANY SAFETY PRECAUTIONS AND PROGRAMS IN CONNECTION WITH THE WORK FOR THE OMISSIONS OF THE CONTRACTOR, SUBCONTRACTORS OR ANY OTHER PERSONS PERFORMING ANY OF THE WORK, OR FOR THE FAILURE OF ANY OF THEM TO CARRY OUT THE WORK IN ACCORDANCE WITH THESE DOCUMENTS.
- THE ARCHITECT ASSUMES NO RESPONSIBILITY FOR ANY EXISTING STRUCTURES AND OR ANY UNFORESEEN PROBLEMS PRIOR TO NEW CONSTRUCTION. THE ARCHITECT ASSUMES NO RESPONSIBILITY FOR ANY DEMOLITION. SITE WORK,
- NEW CONSTRUCTION, OPERATION AND METHODS. ALL AREAS THAT ARE AFFECTED BY ALL ADDITIONS SHALL BE REPAIRED AND OR PATCHED TO A LIKE NEW CONDITION, UNLESS NOTED OTHERWISE.
- THE CONTRACTOR IS TO OBTAIN ALL NECESSARY PERMITS AND APPROVALS BY THE LOCAL AND STATE AS REQUIRED AND TO DELIVER TO THE OWNER A C.O. UPON COMPLETION OF THE PROJECT.
- THE CONTRACTOR SHALL PROVIDE A CONTAINER FOR THE REMOVAL OF DEBRIS DURING CONSTRUCTION. THE CONTRACTOR AND ALL SUBCONTRACTORS WORKING WITH THIS PROJECT
- SHALL KEEP THE SITE CLEAN AND HAZARD FREE AT ALL TIMES AND TO OBIDE ALL "OSHA" AND ALL OTHER SAFETY REGULATIONS. THE CONTRACTOR SHALL LEAVE PREMISES BROOM CLEAN DAILY. THE CONTRACTOR SHALL GUARANTEE ALL WORK SPECIFIED AND/OR DESCRIBED
- BY THESE DRAWINGS AND IS TO FOLLOW ALL NATIONALLY ACCEPTED TRADE PRACTICES.

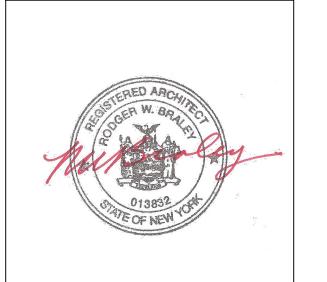SITE NOTES

- THESE PLANS ARE BASED ACCORDANCE TO THE SURVEY INFORMATION PROVIDED TO THE ARCHITECT BY THE OWNER. THEY SHOULD BE REVIEWED BY A LICENSED LAND SURVEYOR AND OR ENGINEER TO VERIFY ALL BUILDING LINES, AND SET BACKS PRIOR TO CONSTRUCTION.
- THE ELEVATION SHOWN ON THE PLAN MAY NOT BE ACCURATE IN EVERY DETAIL, THE OWNER SHALL REVIEW THE PLANS WITH THE CONTRACTOR TO INSURE ACCURACY OF DETAILS AND METHODS PROVIDED BY THE CONTRACTOR. THE CONTRACTOR SHALL BE RESPONSIBLE OF NOTIFYING ALL UTILITY COMPANIES, AND VERIFYING THE LOCATION OF THE SAME UTILITY COMPANIES LINES, SERVICES AND ALL OTHER POSSIBLE EQUIPMENTS OF UTILITY COMPANIES. THE CONTRACTOR SHALL LOCATE AND IDENTIFY THE LOCATIONS OF ALL EXISTING
- UNDERGROUND UTILITIES, AND PROVIDE UNDERGROUND CONNECTIONS TO THEM. THE CONTRACTOR SHALL NOTIFY THE ARCHITECT IMMEDIATELY OF ANY GROUND WATER, EXCESSIVE ORGANIC MATERIAL OR ANY OTHER UNSUITABLE CONDITIONS DISCOVERED DURING SITE PREPARATION AND OR EXCAVATION.
- THE CONTRACTOR SHALL PROVIDE ONE PROPERLY MAINTAINED, PORTABLE TOILET FOR THE ENTIRE DURATION OF THE CONSTRUCTION. THE CONTRACTOR SHALL PROVIDE FROM A REGISTERED LAND SURVEYOR A WRITTEN CERTIFICATE THAT THE LOWEST PORTION OF THE FIRST FLOOR MEET
- OR EXCEED THE REQUIRED FLOOD ELEVATION. ALL DRIVEWAYS AND WALKWAYS FORM WORK SHALL BE APPROVED BY DEVELOPMENT REVIEW REPRESENTATIVE BEFORE ANY WORK CONTINUES. THE CONTRACTOR SHALL REMOVE AND DISPOSE ALL RUBISH, VEGETATION, STUMPS, ROOTS, AND TREES AS SHOWN ON THE PLANS.
- ALL AREAS TO BE COVERED WITH FILL AND GRADED DOWN. THE CONTRACTOR SHALL PROTECT ALL EXISTING TREES SHOWN TO REMAIN AS
- EXTREME CAUTION SHALL BE TAKEN DURING DEMOLITION OF EXISTING BUILDINGS. THE CONTRACTOR SHALL OBSERVE ANY VARIATIONS AND OR ANY UNFORESEEN DISCREPANCIES WITH THE PLANS, AND SHOULD REPORT IMMEDIATELY TO THE
- THE CONTRACTOR SHALL BE RESPONSIBLE FOR ALL SHORING, BRACING AND ALL TEMPORARY SUPPORTS PRIOR OF REMOVING THE EXISTING WALLS, CEILINGS, FLOORS AND ROOFS AS PER ALL LOCAL AND OSHA REGULATIONS.
- THE CONTRACTOR SHALL PROVIDE WEATHERPROOFING AT THE END OF EACH WORK DAY AS REQUIRED TO PREVENT WEATHER DAMAGE. THE ARCHITECT IS NOT RESPONSIBLE FOR FROZEN PIPES AND/OR MOLD CONDITIONS CREATED BY THE CONTRACTORS NEGLIGENCE.
- BACKFILL SHALL NOT BE PLACED UNTIL THE MAIN FLOOR SYSTEM AND BASEMENT CONCRETE INTERIOR FLOOR SLABS ARE INSTALLED. FOOTING DRAINS SHALL BE PROVIDED AS SHOWN, AND APPROPRIATE. THEY SHOULD BE LAID IN GRAVEL BED AND PROTECTED AT THE TOP WITH FILTER FABRIC AND 6" OF 11/2" GRAVEL AROUND & PROVIDE POSITIVE OUTFALL TO A STORM DRAIN OR A DRY-WFII
- THE FINISHED GRADE AND DRIVEWAY SHOULD BE PITCHED AWAY FROM THE BUILDING SUCH THAT ALL THE SURFACE WATER FLOWS AWAY FROM BUILDING. THE FINISHED GRADE HEIGHT SHALL BE A MINIMUM OF 8" BELOW THE ADJACENT FRAMING, OR AS INDICATED ON PLANS.
- THE TOP OF ANY FOUNDATION SHALL EXTEND ABOVE THE ELEVATION OF THE STREET GUTTER AT POINT OF DISCHARGE OR THE INLET OF AN APPROVED DRAINAGE DEVICE A MINIMUM OF 12" PLUS 2 PERCENT.

WIND DESIGN

OPOGRAPHIC SPECIAL WIND WIND BORNI EFFECTS REGION DEBRIS ZON

INSTALLATION OF GAS AND ELECTRIC METERS SHOULD BE IN STRICT ACCORDANCE WITH THE LOCAL UTILITY COMPANY SPECIFICATIONS.

GROUND

SNOW LOAD

40 PSF | 115 MPH

FOUNDATION NOTES

PER SQ. FT.

- IT'S THE RESPONSIBILITY OF THE CONTRACTOR TO CHECK AND COORDINATE DIMENSIONS BETWEEN FOUNDATION AND FLOOR PLANS PRIOR TO CONSTRUCTION. ALL EXCAVATIONS SHOULD BE SUBSTANTIALLY FREE OF WATER DURING FOUNDATION CONSTRUCTION WORK.
- THIS PROJECT HAS BEEN DESIGNED BY ASSUMING THAT ALL THE SOIL BEARING IS 2 KIPS/SQ. FT. (2000#). ALL STRUCTURAL CONCRETE SHALL BE A STONE CONCRETE WITH A 1:3:5 MIX AND HAVE A MINIMUM STRENGTH OF 3,500 PSI AT THE END OF 28 DAYS.

ALL FOOTINGS TO REST ON UNDISTURBED SOIL CAPABLE OF SUPPORTING 2 TONS

- REFERENCE THE PLANS FOR SIZE AND QUANTITY OF REINFORCING BARS. ALL FOOTINGS SHALL BE BELOW THE FINISHED GRADE MINIMUM OF 3'-6" IN ROCKLAND COUNTY, 3'-6" IN ORANGE COUNTY OR OTHERWISE SHOWN ON THE PLAN.
- PROVIDE EXPANSION JOINTS AT PERIMETERS OF ALL CONCRETE SLABS. ALL INTERIOR FOOTINGS SHALL STEP DOWN TO PERIMETER WALL FOOTING DEPTH AT ALL FOOTING INTERSECTIONS.
- ALL SUB GRADE FILL MATERIAL SHALL BE COMPACTED TO A DENSITY OF 96. ALL CONCRETE SLABS SHALL BE A MINIMUM OF 4 ? THICK — REINFORCED WITH 6x6/10x10 WELDED WIRE MESH ON 6 MIL VAPOR BARRIER ON 4" OF 3/4" GRAVEL, UNLESS SHOWN OTHERWISE AND TO RECEIVE A SMOOTH FINISH.
- ALL CONCRETE PAVING SHALL RECEIVE A FINE BROOM FINISH UNLESS SHOWN OTHERWISE. ALL CONCRETE SLABS TO RECEIVE CONTROL JOINTS (1/2" SAW CUTS) AT A MAXIMUM OF 25'x25' TO CONTROL CRACKING WITH SHRINKAGE.
- SLOPE ALL CONCRETE SLABS TO DRAIN TO EXTERIOR. SLOPES IN GARAGES SHALL BE A MINIMUM OF 1/8"=1'-0" UNLESS SHOWN OTHERWISE. MASONRY AND CONCRETE CONTRACTOR SHALL INSTALL ALL ANCHOR BOLTS, PLATES, CHASES, SLOTS, SLEEVES, ETC. AS REQUIRED BY TRADES.
- CAULK WEATHER-TIGHT ALL OPENINGS. EXTERIOR OF THE CONCRETE WALLS TO BE COATED WITH RUB-R-WALL COATING OR EQUAL. INTERIOR COLUMNS TO BE 4" DIAM. STANDARD STEEL - PROVIDE BASE & TOP PLATES. INTERIOR COLUMNS OVER 9'-0" IN HEIGHT TO BE 5" DIAM. STANDARD STEEL COLUMNS. EXTREME CAUTION TO BE USED IN DELIVERY OF THE STEEL COLUMNS. MUST NOT BE
- DROPPED AT ANY TIME. DOWELS MUST BE TIED INTO FOOTING RE-BARS PRIOR TO POURING FOOTINGS CONCRETE AIR-ENTRRAINED TO NOT LESS THAN 5% OR NO MORE THAN 7% WHERE REQUIRED.

AND SUPPLIED WITH NUT & WASHER TIGHTENED TO EACH BOLT

FOUNDATION ANCHOR BOLTS SHALL BE LOCATED IN THE MIDDLE THIRD OF WIDTH OF SILL >.

FRAMING NOTES

- ALL STANDARD FRAMING LUMBER TO BE HEMLOCK FIR #2 OR BETTER UNLESS OTHERWISE NOTED. ALL ENGINEERED BEAMS INDICATED ON THE PLANS ARE DESIGNED USING THIS SPECIFIC MANUFACTURER AND SHALL BE INSTALLED PER THE MANUFACTURERS SPECIFICATIONS ONLY. WHEN USING MULTIPLE MEMBER ENGINEERED BEAMS, THE FRAMER SHALL REFERENCE WITH
- THE SPECIFIC MANUFACTURERS NAILING GUIDE. PROVIDE METAL FLASHING AT ALL EXTERIOR DOORS, WINDOWS AND OPENINGS UNLESS SHOWN OTHERWISE.
- INSTALL 36" WIDE ICE & WATER SHIELD ? AT ALL ROOF EDGES, IN VALLEYS, UP AGAINST WALL JUNCTIONS, OVER HIPS AND WRAP OVER ALL FACIAS. THE SHIELD SHALL COVER MINIMUM 24" TOP OF EXTERIOR SIDE OF EXTERIOR WALLS. PROVIDE OPTIONAL SNOW-GAURDS IF REQUIRED WITH THE STANDARD SPACING ALONG THE BOTTOM EDGE OF THE ROOF. FRAMING NOTES DIMENSIONS ARE TO THE NEAREST INCH, ACTUAL ROOM SIZES MAY VARY
- DUE TO GYPSUM BOARD. ALL WOOD FRAMING IN DIRECT CONTACT WITH SOIL, CONCRETE, MASONRY OR WEATHER SHALL BE PRESSURE TREATED (AWPA STANDARD C2, C3)
- ALL FRAMING BELOW THE REQUIRED FLOOD ELEVATION AS SET FORTH BY FEMA AND LOCAL BUILDING OFFICIALS SHALL BE PRESSURE TREATED.
- SECURE ALL TEMPORARY RAILINGS WITH GUARDS TO BE INSTALLED AROUND ALL FLOOR OPENINGS AND OPEN DOOR OPENINGS. PROVIDE TEMPORARY RAMPS AND/OR STAIRS TO BE INSTALLED AT ALL LEVELS. ALL LUMBER TO BE SOUND, DRY AND FREE FROM ROT, KNOTS, AND SPLITS.
- ALL FRAMING SHALL BE FRAMED AT 16 "O.C. UNLESS SHOWN OTHERWISE. FOR ALL CONVENTIONAL FLOOR FRAMING PROVIDE A MINIMUM OF ONE ROW OF 5/4 CROSS BRIDGING FOR ALL JOISTS WITH SPANS OVER 12'-0 ? OR SHOWN OTHERWISE ON THE
- PROVIDE A MINIMUM OF DOUBLE JOISTS BELOW ALL PARALLEL PARTITIONS. MAJOR APPLIANCES, BATH FIXTURES, AND AT ALL CANTILEVERS, UNLESS SHOWN OTHERWISE. PROVIDE A MINIMUM OF DOUBLE ALL JOISTS AT OPENINGS IN FLOORS, CEILINGS AND ROOFS. PROVIDE A MINIMUM OF DOUBLE WALL STUDS AROUND ALL WALL OPENINGS, JACK STUDS UNDER ALL HEADERS, TRIPLE STUDS AT ALL CORNERS.
- PROVIDE POSTS AT ALL RIDGE. HIP AND VALLEY INTERSECTIONS DOWN TO A MINIMUM OF TRIPLE 2 ?x8? CEILING JOISTS. ALL FRAMING SHALL BE FRAMED CROWN UP UNLESS AT CANTILEVERS OR SHOWN OTHERWISE.
- SOLID BLOCKING SHALL BE PROVIDED UNDER ALL POSTS THAT DON'T REST DIRECTLY ON ALL INTERIOR WOOD POSTS SHALL BE SOLID STUDS, AND TO BE A MINIMUM OF THE WIDTH OF THE BEAM SUPPORTING IT AND PROVIDE MINIMUM ONE KING STUD AT EITHER SIDE.
- BRACE ALL WALLS DURING CONSTRUCTION. ALL WALL FRAMING OF 9'-0" AND GREATER SHALL HAVE CATS (SOLID BLOCKING) AT MIDHEIGHT ALL DOORS, WINDOWS AND OPENINGS SHALL HAVE A MINIMUM HEADER TO BE AS FOLLOWS UNLESS SHOWN OTHERWISE ON PLANS. UP TO 5'-0" USE (2)2"x10", UP TO 8'-0" USE (3)2"x10" OR (2)2"x12" OPENINGS GREATER THAN 8'-0" SEE PLANS FOR
- PROVIDE FASTENER NAILS AS FOLLOWS; 10d AT ALL GENERAL FRAMING AND 8d AT ALL PLYWOOD, 4" SPACING MAX. — TABLES R602.3(1) THROUGH R602.3(4).

FIRE BLOCKING SHALL BE PROVIDED AS FOLLOWS

- IN CONCEALED SPACES OF STUD WALLS AND PARTITIONS, INCLUDING FURRED SPACES, AT THE CEILING & FLOOR LEVELS. CONCEALED HORIZ. FURRED SPACES SHALL ALSO BE FIRE BLOCKED AT INTERVAL NOT EXCEEDING 10 FEET. BATTS OR BLANKETS OF MINERAL OR GLASS FIBER SHALL BE ALLOWED AS FIRE BLOCKING IN WALLS CONSTRUCTED USING ROWS OF STUDS OR STAGGERED STUDS.
- 2. AT ALL INTERCONNECTIONS BET. CONCEALED VERT. & HORIZ. SPACES SUCH AS OCCUR AT SOFFITS, DROP CEILINGS AND COVE CEILINGS. 3. IN CONCEALED SPACES BET. STAIR STRINGERS AT TOP & BOTTOM OF THE RUN. ENCLOSED SPACES UNDER STAIRS SHALL COMPLY w/SECTION R311.2.2.
- 4. AT OPENINGS AROUND VENTS, PIPES AND DUCTS AT CEILING AND FLOOR LEVEL. W/ AN APRVD MATERIAL TO RESIST THE FREE PASSAGE OF FLAME AND PRODUCTS OF COMBUSTION. FOR THE FIRE BLOCKING OF CHIMNEYS & FIREPLACES, SEE SECTION R1001.16.
- FIRE BLOCKING OF CORNICES OF A 2 FAMILY DWELLING IS REQ'D AT THE LINE OF DWELLING UNIT SEPARATION.

ROOFING & SIDING

TABLE 301.2(1) CLIMATIC AND GEOGRAPHIC DESIGN CRITERIA

DESIGN

CATAGORY

CATAGORY B

- ROOFING, SIDING, TRIM, AND OTHER MATERIALS SHALL BE INSTALLED IN STRICT ACCORD WITH THEIR RESPECTIVE MANUFACTURERS SPECIFICATIONS AND INDUSTRY STANDARDS.
- PROVIDE ALUMINUM GUTTERS & ROOF DRAIN LEADERS (RDLs) AS REQUIRED RDLs AT OUTLET TO BE CONNECTED TO SITE STORM DRAINAGE SYSTEM. PROVIDE APPROVED SNOW GUARDS AT ROOF EDGES WITH PITCH EXCEEDING 7:12 OVER ALL DOORWAYS, DECKS & WALKWAYS WITHIN 36" OF DWELLING ROOFING, SIDING, TRIM, AND OTHER MATERIALS COLORS TO BE DETERMINED FROM BUILDERS SELECTION PRIOR TO ORDERING. ARCHITECT IS NOT RESPONSIBLE FOR COLOR AND/OR MATERIAL SELECTIONS,

SUBJECT TO DAMAGE FROM

42"

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MODERATI

HFAV

WEATHERING | DEPTH

SEVERE

WINTER

DESIGN

TEMP

DOOR & WINDOW NOTES

- ALL WINDOWS AND EXTERIOR DOORS SHALL COMPLY WITH THE ENERGY CONSERVATION CODE OF N.Y.S. AND FOR THE COUNTY THIS PROJECT IS
- ALL DOORS SHALL CONFORM TO THE STATE CODE SIZE REQUIREMENTS. WINDOW SCHEDULE IS FOR DESIGN INTENT ONLY. THE CONTRACTOR SHALL VERIFY WITH OWNER ALL WINDOWS, DOOR, AND ADDITIONAL OPTIONS SUCH AS,
- COLOR, HARDWARE PRIOR TO ORDERING ALL WINDOWS AND DOORS SHALL BE INSTALLED WITH STRICT ACCORDANCE TO
- THEIR PARTICULAR MANUFACTURERS SPECIFICATIONS AND TO VERIFY WINDOW ROUGH OPENINGS WITH THE MANUFACTURER. ALL HEADER HEIGHTS TO BE 6'-9" ABOVE THE FINISHED FLOOR, UNLESS NOTED
- ALL WINDOWS IN HABITABLE SPACES SHALL COMPLY WITH THE RESIDENTIAL CODE OF THE N.Y.S. EGRESS REQUIREMENTS. THESE WINDOWS SHALL HAVE A SILL HEIGHT OF NOT GREATER THAN 44 ? ABOVE FINISHED FLOOR. THESE WINDOWS SHALL HAVE A MIN. OF 5.7 SQ. FT. CLEAR OPENING AND 10.3 SQ. FT.
- OF GLASS AREA FOR NATURAL LIGHT. AT ALL EGRESS BASEMENT WINDOWS THAT ARE BELOW THE FINISHED GRADE
- SHALL BE PROVIDED WITH AN APPROVED WINDOW WELL AND DRAINAGE AS PER THE N.Y.S. AND LOCAL CODES. ALL GLAZING LESS THAN 18" ABOVE FINISHED FLOOR/SURFACE. AND ALL GLASS
- TUB AND/OR SHOWER ENCLOSURES SHALL BE TEMPERED GLASS. ALL FIXED GLASS SHALL BE IN FRAMES TO MATCH THE MANUFACTURER OF OPERABLE WINDOWS.
- ALL WINDOWS SHALL BE MANUFACTURED BY ANDERSEN OR EQUAL UNLESS SHOWN ALL SKYLIGHTS, METAL FLUES, VENTS, STACKS OR ANY OTHER ROOF
- ACCESSORIES THAT REQUIRE FLASHING SHALL BE INSTALLED AS PER THE MANUFACTURERS SPECIFICATIONS. PROVIDE ADDITIONAL ALUMINUM BLIND FLASHING WHERE REQUIRED TO INSURE WATER TIGHT CONDITIONS. INSTALL FLASHING AT ALL ENTRANCE SLABS ADJACENT TO WALL CONSTRUCTION.
- PROVIDE ADEQUATE AIR SPACE BEHIND BRICK, STONE AND OTHER SIDINGS AS ALL BEADS, STOPS AND TRIM SHALL BE MANUFACTURED FROM RUST RESISTANT ALL EXTERIOR SWING DOORS SHALL BE MANUFACTURED BY THERMA-TRU OR
- EQUAL UNLESS SHOWN OTHERWISE. ALL WINDOW & DOOR JAMBS TO BE FOAM SEALED & WEATHER STRIPPED ON EXTERIOR AS PER THE 2015 INTERNATIONAL ENERGY CONSERVATION

DRYWALL NOTES

- ALL GYPSUM BOARD DRYWALL CUT JOINTS SHALL BE ADJACENT TO CORNERS. NO BUTT JOINTS IN WALL SHALL BE PERMITTED. ALL CORNERS AND JOINTS SHALL RECEIVE TWO COATS OF JOINT COMPOUND FEATHERED SMOOTH AND ALL DIMPLES CREATED BY FASTENERS SHALL
- RECEIVE THREE COATS OF JOINT COMPOUND FEATHERED SMOOTH. ALL GYPSUM BOARD SHALL BE IN ACCORDANCE WITH THE GYPSUM CONSTRUCTION HANDBOOK, PUBLISHED BY THE UNITED STATES GYPSUM
- ALL MATERIALS SHALL BE FURNISHED BY THE UNITED STATES GYPSUM COMPANY, NATIONAL GYPSUM COMPANY, CELOTEX CORP., OR OTHER APPROVED MANUFACTURER.
- USE WATERPROOF GYPSUM BOARD AT ALL TUBS, SHOWER SURROUNDS AND OTHER WET LOCATIONS. (DUR-O-ROCK OR EQUAL)

STAIR & RAILING NOTES

- ALL STAIRS AND RAILINGS SHALL COMPLY WITH THE 2020 NYS RESIDENTIAL CODE ALL STAIRWAYS SHALL NOT BE LESS THAN 36 "IN CLEAR WIDTH AT ALL POINTS ABOVE THE PERMITTED HANDRAIL HEIGHT AND BELOW THE REQUIRED HEADROOM HEIGHT.
- HANDRAILS SHALL NOT PROJECT INTO THE STAIRWAY MORE THAN 4 COMBINED CLEAR WIDTH OF 27 ? IF THERE IS TWO HANDRAILS AND 31 THERE IS ONLY ONE HANDRAIL WITH A MINIMUM WALL CLEARANCE OF 1 THE MINIMUM HEADROOM IN ALL PARTS OF STAIRWAYS SHALL NOT BE LESS THAN 6'-8" MEASURED VERTICALLY FROM THE SLOPED PLANE ADJOINING THE
- TREAD NOSING OR FROM THE FLOOR SURFACE OF THE LANDING OR ENCLOSED ACCESSIBLE SPACE UNDER STAIRS SHALL HAVE WALLS, UNDER STAIR SURFACE AND SOFFITS PROTECTED ON THE ENCLOSED SIDE w/\" GYP. BD.
- THE MAXIMUM RISER HEIGHT IS 8 1/4" THE GREATEST RISER HEIGHT SHALL NOT EXCEED THE SMALLEST BY MORE THAN 3/8". THE MINIMUM TREAD DEPTH IS 9 ? THE GREATEST TREAD DEPTH SHALL NOT
- EXCEED THE SMALLEST BY MORE THAN 3/8". WINDER TREADS ARE PERMITTED PROVIDED THAT THE WIDTH OF THE TREAD AT A POINT IS NOT MORE THAN 12" AND FROM THE NARROW SIDE IS NOT LESS THAN 10". WINDER TREADS SHALL HAVE A MINIMUM TREAD DEPTH OF 6" AT ANY
- THE GREATEST WINDER TREAD DEPTH AT THE 12" WALK LINE SHALL NOT EXCEED THE SMALLEST BY MORE THAN
- A NOSING NOT LESS OF 3/4" AND NOT GREATER THAN 1 ON STAIRWAYS WITH SOLID RISERS.
- THE GREATEST NOSING PROJECTION SHALL NOT EXCEED THE SMALLEST BY MORE OPEN RISERS ARE PERMITTED, PROVIDED THAT THE OPENING BETWEEN TREADS DOES NOT PERMIT THE PASSAGE OF A 4" DIAMETER SPHERE. HANDRAIL HEIGHT SHALL BE A MINIMUM OF 34 " AND 38
- OPEN RAILINGS AND GUARDS SHALL NOT BE GREATER THAN 4". IF DECKS OR PLATFORMS ARE 8'-0" AND GREATER ABOVE THE FINISHED GRADE THAN THE HANDRAIL SHALL BE 42" IN HEIGHT.

TRIM & PAINTING NOTES

FLOOD

YAZARDS

NONE

ICE BARRIER

UNDERLAYMENT

REQUIRED

YES

- ALL CLOSETS SHALL HAVE AS A MINIMUM OF ONE (1) HIGH SHELF AND ONE (1) ROD FOR HANGING CLOTHING. PROVIDE FIVE (5) SHELVES IN LINEN CLOSETS. THE CONTRACTOR SHALL DOUBLE CHECK AND VERIFY ALL AS BUILT DIMENSIONS AND CONDITIONS PRIOR OF ORDERING CABINETS, COUNTER TOPS AND
- ALL EXPOSED BASED CABINET SIDES SHALL HAVE TOE SPACE UNLESS SHOWN OTHERWISE.
- ALL PAINTS AND STAINS SHALL BE OF A MANUFACTURER AS SCHEDULED OR AS DIRECTED BY BUILDER. ALL INTERIOR GYPSUM BOARDS, WALLS AND CEILINGS, SHALL RECEIVE ONE COAT
- PRIMER AND TWO COATS OF PAINT OF BENJAMIN MOORE OR EQUAL. ALL INTERIOR WOOD, TRIM, SHELVING AND OAK FLOORS SHALL BE FINISHED AS
- SCHEDULED OR AS DIRECTED BY BUILDER. ALL INTERIOR DOORS, TRIM AND EXPOSED WOOD SHALL BE SANDED COMPLETELY SMOOTH PRIOR TO APPLYING FINISH.
- ALL EXPOSED FERROUS METAL SHALL BE PAINTED WITH A RUST INHIBITOR AND TWO COATS OF ENAMEL.

FREEZING

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INDEX

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- **PUMBING NOTES** ALL PLUMBING WORK EQUIPMENT AND FIXTURES SHALL BE PLACED AND INSTALLED PER THE 2020 PLUMBING CODE OF NEW YORK STATE AND INDUSTRY STANDARDS.
- THE CONTRACTOR SHALL VERIFY WITH THE OWNER ALL FIXTURES. MODELS. COLORS ETC. PRIOR OF ORDERING INSTALL IRON PIPING UNDER ALL CONCRETE SLABS. GAS LINES TO BE GROUNDED TO BLACK PIPE AT SERVICE ENTRY VENT STACK SHALL EXTEND ABOVE
- ROOF 18" OF 12" ABOVE AVG SNOWFALL. THE PLUMBING CONTRACTOR SHALL PROVIDE DRYER VENTS AS PER THE RESIDENTIAL CODE OF N.Y.S. THE PLUMBING CONTRACTOR SHALL NOT DRILL OR CUT ANY STRUCTURAL
- GIRDERS, HEADERS, BEAMS WITHOUT PRIOR CONSENT FROM THE *ARCHITECT* DRILLING AND CUTTING OF FLOOR JOISTS SHALL BE IN STRICT
- ACCORDANCE WITH THE CODE AND/OR SAID JOIST MANUFACTURERS THE PLUMBING CONTRACTOR SHALL VERIFY FIXTURE AND PIPE LOCATIONS WITH OTHER TRADES INVOLVED WITH THIS JOB PRIOR TO INSTALLATION. THE PLUMBING CONTRACTOR SHALL PROVIDE SHOWER PANS UNDER
- CLOTHES WASHER WITH A DRAIN CONNECTED TO THE WASTE PLUMBING THE PLUMBING CONTRACTOR SHALL PROVIDE WHOLE HOUSE BACK-FLOW PREVENTION VALVES AND ADEQUATE CLEAN—OUTS AS REQUIRED BY
- PROVIDE 12"x12" ACCESS PANEL TO WHIRLPOOL TUB MOTOR AND SIMULAR FQUIPMENT.
- THE PLUMBING CONTRACTOR SHALL PROVIDE AND INSTALL EQUIPMENT FLUES AS REQUIRED BY THE RESIDENTIAL CODE OF N.Y.S. ALL HOSE BIBS SHALL BE FREEZE PROOF TYPE.
- LOCATIONS AND QUANTITY SHALL BE AS PER OWNERS INSTRUCTIONS. UNLESS SHOWN OTHERWISE A MINMUM OF TWO (2) HOSE BIBS SHALL BE PROVIDED; ONE (1) LOCATED AT THE FRONT AND ONE (1) LOCATED AT REAR

MECHANICAL NOTES

- ALL MECHANICAL WORK (FURNACE, BOILERS, HVAC, HOT WATER, ETC.) SYSTEMS, AND INSTALLATION SHALL COMPLY IN ACCORDANCE WITH THE 2020 PLUMBING, MECHANICAL, AND FUEL CODES OF NEW YORK STATE AND INDUSTRY STANDARDS.
- THE SYSTEMS SHALL BE DESIGNED AND GUARANTEED BY THE MECHANICAL SUBCONTRACTOR TO MEET AND/OR EXCEED THE FOLLOWING REQUIREMENTS: MAINTAIN 70 $^{
 m o}$ F INSIDE WHEN THE OUTSIDE TEMPERATURE IS 100°F AND MAINTAIN 70°F INSIDE WHEN THE OUTSIDE TEMPERATURE IS
- ALL HEATING LINES SHALL CONTAIN ANTIFREEZE. LOCATE ATTIC MECHANICAL UNITS ON GALVANIZED DRIP PANS, DRAINED. ALL DUCTS SHALL BE FIBERGLASS INSULATED TYPE (EXCEPT GALVANIZED UNDERSLAB DUCTWORK).
- THE MECHANICAL SUBCONTRACTOR SHALL SUBMIT SHOP DRAWINGS TO THE BUILDER FOR APPROVAL PRIOR TO ANY EACH SYSTEM SHALL BE SEPARATE AND COMPLETE WITH EACH SYSTEM HAVING SUPPLEMENTAL STRIP HEAT.
- CARRIER, TRANE, LENNOX, AND YORK ARE APPROVED MANUFACTURERS FOR THE MECHANICAL UNIT. ANY SUBSTITUTES MUST BE APPROVED IN WRITING BY THE ARCHITECT OR OWNER. ALL MECHANICAL UNITS IN ATTIC SHALL BE LOCATED IN SUCH MANNER THAT
- THEY SHALL NOT CAUSE AN OBSTRUCTION TO FUTURE ATTIC FLOORING. PROVIDE THE PROPER FIRE RATED SEPARATION AT THE MECHANICAL ROOM (FURNACE, HVAC, HOT WATER, ETC. AS PER THE BUILDING CODE PROVIDE BACKDRAFT DAMPER EXHAST DUCTS TO BE MIN. 0.016 INCHES RIGID METAL. AMX HORZT. LENGTH NOT TO EXCEED 25 FT.
- BATHS & LAVS WITHOUT OPERABLE WINDOWS OR WDWS WITH LESS THAN 1.5 S.F. OPENING SHALL BE MECHANICALLY VENTED TO INTERMITTENT VENTILATION TO BE MIN. 50 CFM, CONTINUOUS VENTING TO BE MIN. 20 CFM.

PROVIDE BOOSTER FAN IF GREATHER THAN 25 FI

ELECTRICAL NOTES

- ALL OUTLETS, FIXTURES AND ALL OTHER ELECTRICAL WORK SHALL BE PLACED, AND INSTALLED AS PER THE 2018 NFPA LATEST EDITION., THE LATEST EDITION OF THE N.E.C., N.B.F.U., AND THE LOCAL UTILITY CO. ELECTRICAL PANELS SHALL BE FULLY RECESSED AND HAVE ALL CIRCUITS
- CLEARLY LABELED. A MINIMUM OF 20 % OF CIRCUITS SHALL BE FOR FUTURE USE FOR EACH PANEL USED.
- TELEPHONE AND TELEVISION OUTLETS SHALL BE WIRED TO LOCAL PROVIDERS SPECIFICATIONS TO A POINT OF ENTRY APPROVED BY OWNER UNLESS SHOWN ON PLANS OTHERWISE. THE ELECTRICAL CONTRACTOR SHALL PROVIDE MECHANICAL EXHAUST FANS; FOR ALL RANGES, AND IN ALL LAUNDRY, TOILET, TUB, AND
- SHOWER AREAS. ALL FAN FIXTURES SHALL BE SWITCHED SEPARATELY AND VENTED TO THE EXTERIOR. THE ELECTRICAL CONTRACTOR SHALL PROVIDE A SWITCH FOR THE
- DISHWASHER LOCATED IN SINK CAB. ALL RECEPTACLES SHOWN ABOVE THE COUNTER SHALL HAVE THE BOTTOM FLUSH WITH TOP OF THE BACK SPLASH. THE ELECTRICAL CONTRACTOR SHALL NOT DRILL OR CUT ANY
- STRUCTURAL GIRDERS, HEADERS AND BEAMS WITHOUT PRIOR CONSENT FROM THE ARCHITEC THE CONTRACTOR SHALL CONSULT AND COORDINATE WITH OTHER TRADES INVOLVED WITH THIS PROJECT PRIOR TO INSTALLATION.
- THE ELECTRICAL CONTRACTOR SHALL VERIFY WITH THE OWNER ALL ELECTRICAL DEVICE AND FIXTURE LOCATIONS. THE ELECTRICAL CONTRACTOR SHALL VERIFY WITH THE OWNER ALL ELECTRICAL DEVICE AND FIXTURE OPTIONS SUCH AS COLOR.
- AND STYLE PRIOR OF ORDERING ALL SMOKE AND CARBON MONOXIDE DETECTORS SHALL BE HARDWIRED AND INTERCONNECTED WITH BATTERY PROVIDE ONE SMOKE DETECTORS AS INDICATED ON PLANS AND AS PER ALL CODE REQUIREMENTS AND PROVIDE A MINIMUM OF ONE CARBON MONOXIDE DETECTOR
- LOCATE SMOKE DETECTORS ON FLAT CEILINGS NO CLOSER THAN 16 FROM WALL. ALL OUTLETS TO BE TAMPERPROOF.

 ARC—FAULT OUTLETS IN ALL ROOMS EXCEPT KITCHEN AND BATHS.
- ALL RECESSED LIGHTS TO MEET "IC" REQUIREMENTS FOR AIR INFII TRATION 50% OF LAMPS TO BE HIGH EFFICENCY
- OUTDOOR RECEPTACLES MUST BE GFCI PROTECTED AS PER LATEST NEC RECEPTACLES MUST BE ON A MINIMUM OF 2 BRANCH CIRCUITS AS PER LATEST NEC BATHROOM GFCI OUTLETS TO BE ON STANDALONE BRANCH CIRCUIT AS PER LATEST NEC ALL ELECTRICAL WORK TO BE TAMPER RESISTANT

ALL ELECTRICAL WORK TO COMPLY WITH THE NYS AND INTERNATIONAL ELECTRIC CODE

ON EVERY FLOOR.

- ADDITIONAL NOTES ALL THERMOSTATS TO BE PROGRAMABLE - DIGITAL AS MFG. BY WHITE ROGERS
- OR EQUAL ALL SUPPLY PIPING AND/OR DUCT WORK TO RECIEVE R-8 INSULATION WHEN IN UNCONDITIONED SPACES
- ALL HEATING AND/OR COOLING PUMPS TO BE VARIABLE SPEED OF [HP. ALL PLUMBING & PIPING TO COMPLY WITH APPLICABLE 2020 PLUMBING CODE OF NYS

FLOOR JOIST SPANS FOR COMMON LUMBER SPECIES (RESIDENTIAL SLEEPING AREAS, LIVE LOAD=30 psf, L/Δ =360

			DEAD LOAD = 10 psf			DEAD LOAD = 20 psf				
			2x6	2x8	2x10	2x12	2x6	2x8	2x10	2×12
10107				•	MA	XIMUM FLO	OOR JOIST	SPANS		
JOIST SPACING (inches)	SPECIES AND GRADE		(ftin.)	(ftin.)	(ftin.)	(ftin.)	(ftin.)	(ftin.)	(ftin.)	(ft.—in.)
	DOUGLAS FIR-LARCH #	<u>!</u> 2	11-10	15-7	19-10	23-4	11-8	14-9	18-0	20-11
12	HEM-FIR #	<u>!</u> 2	11-0	14-6	18–6	22-6	11-0	14-4	17-6	20-4
	SPRUCE-PINE-FIR #	<u></u> 2	11-3	14-11	19-0	23-0	11–3	14-7	17-9	20-7
	DOUGLAS FIR-LARCH #	<u>{</u> 1	10-11	14-5	18-5	21-4	10-8	13-6	16-5	19-1
	DOUGLAS FIR-LARCH #	<u></u> 2	10-9	14-2	17–5	20-3	10-1	12-9	15-7	18-1
	HEM-FIR #	<u>{</u> 1	10-6	13-10	17–8	21-1	10-6	13-4	16-3	18-10
16	HEM−FIR #	<u></u> 2	10-0	13-2	16-10	19-8	9-10	12-5	15-2	17-7
	SPRUCE-PINE-FIR #	<u>!</u> 1	10-3	13-6	17-2	19-11	9-11	12-7	15-5	17-10
	SPRUCE-PINE-FIR #	<u></u> 2	10-3	13–6	17-2	19-11	9-11	12-7	15-5	17-10
	DOUGLAS FIR-LARCH #	<u>1</u> 2	10-1	13-0	15-11	18-6	9-3	11-8	14-3	16-6
19.2	HEM-FIR #	<u> </u> 2	9-5	12-5	15-6	17-1	8-11	11-4	13-10	16-1
	SPRUCE-PINE-FIR #	<u></u> 2	9-8	12-9	15–8	18-3	9-1	11-6	14-1	16-3
	DOUGLAS FIR-LARCH #	<u>!</u> 2	9-3	11-8	14-3	16-6	8-3	10-5	12-9	14-9
24	HEM-FIR #	<u> </u> 2	8-9	11-4	13-10	16-1	8-0	10-2	12-5	14-4
		<u>!</u> 2	8-11	11-6	14-1	16-3	8-1	10-3	12-7	14-7
NOTE:	CHECK SOURCES FOR AVAIL	ΔΕ	RILITY OF	LIIMRER IN	J I FNGTHS	S GREATER	THAN 20) FFFT		

NOTE: CHECK SOURCES FOR AVAILABILITY OF LUMBER IN LENGTHS GREATER THAN 20 FEET.

FLOOR JOIST SPANS FOR COMMON LUMBER SPECIES (RESIDENTIAL LIVING AREAS, LIVE LOAD=40 psf, L/Δ =360)

			DEAD LOAD = 10 psf			DEAD LOAD = 20 psf				
			2x6	2x8	2x10	2x12	2x6	2x8	2x10	2x12
IOICT					MAX	IMUM FLO	OR JOIST	SPANS		
JOIST SPACING (inches)	SPECIES AND GRADE		(ftin.)	(ftin.)	(ftin.)	(ftin.)	(ftin.)	(ftin.)	(ft.—in.)	(ft.—in.)
	DOUGLAS FIR-LARCH	#2	10-9	14-2	18-0	20-11	10-8	13–6	16-5	19-1
12	HEM-FIR	#2	10-0	13-2	16-10	20-4	10-0	13–1	16-0	18-6
	SPRUCE-PINE-FIR	#2	10-3	13-6	17-3	20-7	10-3	13–3	16-3	18-10
	DOUGLAS FIR-LARCH	#1	9-11	13-1	16-5	19-1	9-8	12-4	15-0	17–5
	DOUGLAS FIR-LARCH	#2	9-9	12-9	15-7	18-1	9-3	11–8	14-3	16-6
	HEM-FIR	#1	9-6	12-7	16-0	18-10	9-6	12-2	14-10	17-2
16	HEM-FIR	#2	9-1	12-0	15-2	17-7	8-11	11-4	13-10	16-1
	SPRUCE-PINE-FIR	#1	9-4	12-3	15-5	17-10	9-1	11–6	14-1	16-3
	SPRUCE-PINE-FIR	#2	9-4	12-3	15-5	17-10	9-1	11-6	14-1	16-3
	DOUGLAS FIR-LARCH	#2	9-2	11-8	14-3	16-6	8-5	10-8	13-0	15-11
19.2	HEM-FIR	#2	8-7	11-3	13-10	16-1	8-2	10-4	12-8	14-8
	SPRUCE-PINE-FIR	#2	8-9	11-6	14-1	16-3	8-3	10-6	12-10	14-10
	DOUGLAS FIR-LARCH	#2	8-3	10-5	12-9	14-9	7-6	9-6	11-8	13-6
24	HEM-FIR	 #2	7-11	10-2	12-5	14-4	7-4	9-3	11-4	13-1
	SPRUCE-PINE-FIR	#2	8-1	10-3	12-7	14-7	7–5	9–5	11-6	13-4

CHECK SOURCES FOR AVAILABILITY OF LUMBER IN LENGTHS GREATER THAN 20 FEET

MINIMUM UNIFORMLY DISTRIBUTED LIVE LOADS (PSF) REQ'D
EXTERIOR BALCONIES	50
DECKS	40
PASSENGER VEHICLE GARAGES	50
ATTICS WITHOUT STORAGE	10
ATTICS WITH STORAGE	20
ROOMS OTHER THAN SLEEPING	40
SLEEPING ROOMS	30
STAIRS	40
STAIR TREADS	100
GUARDS AND HANDRAILS	50
ROOF LOAD - ROOF SHALL BE DESIGNED	
FOR THE LIVE LOAD INDICATED OR THE	
SNOW LOAD INDICATED,	
WHICHEVER IS GREATER	30

SQUARE FOOTAGE			
FLOOR	EXISTING S.F.	PROPOSED S.F.	
BASEMENT	1,365'	2,712'	
FIRST FLOOR	1,801'	2,712'	
SECOND FLOOR	1,071'	1,730'	
TOTAL	4,237'	7,154'	



MONROE, N.Y. 10950 (845) 492-1783 Email: office@szdrawings.com

PROJECT:


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DRAWN BY:	Shlome Glauber
DATE:	7/15/2024
DATE:	8/2/2024
DATE:	8/28/2024
DATE:	1/13/2025
DATE:	3/10/2025

RODGER BRADLEY ARCHITECTS


NYS LIC. NO. 013-832 50 PLATTS HILL ROAD NEWTOWN, CT 06470

T: 203.426.9918 Email: rbraley2@sbcglobal.net

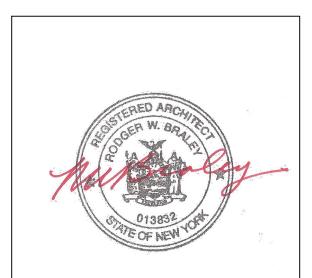

DESCRIPTION: SP-01

AS NOTED

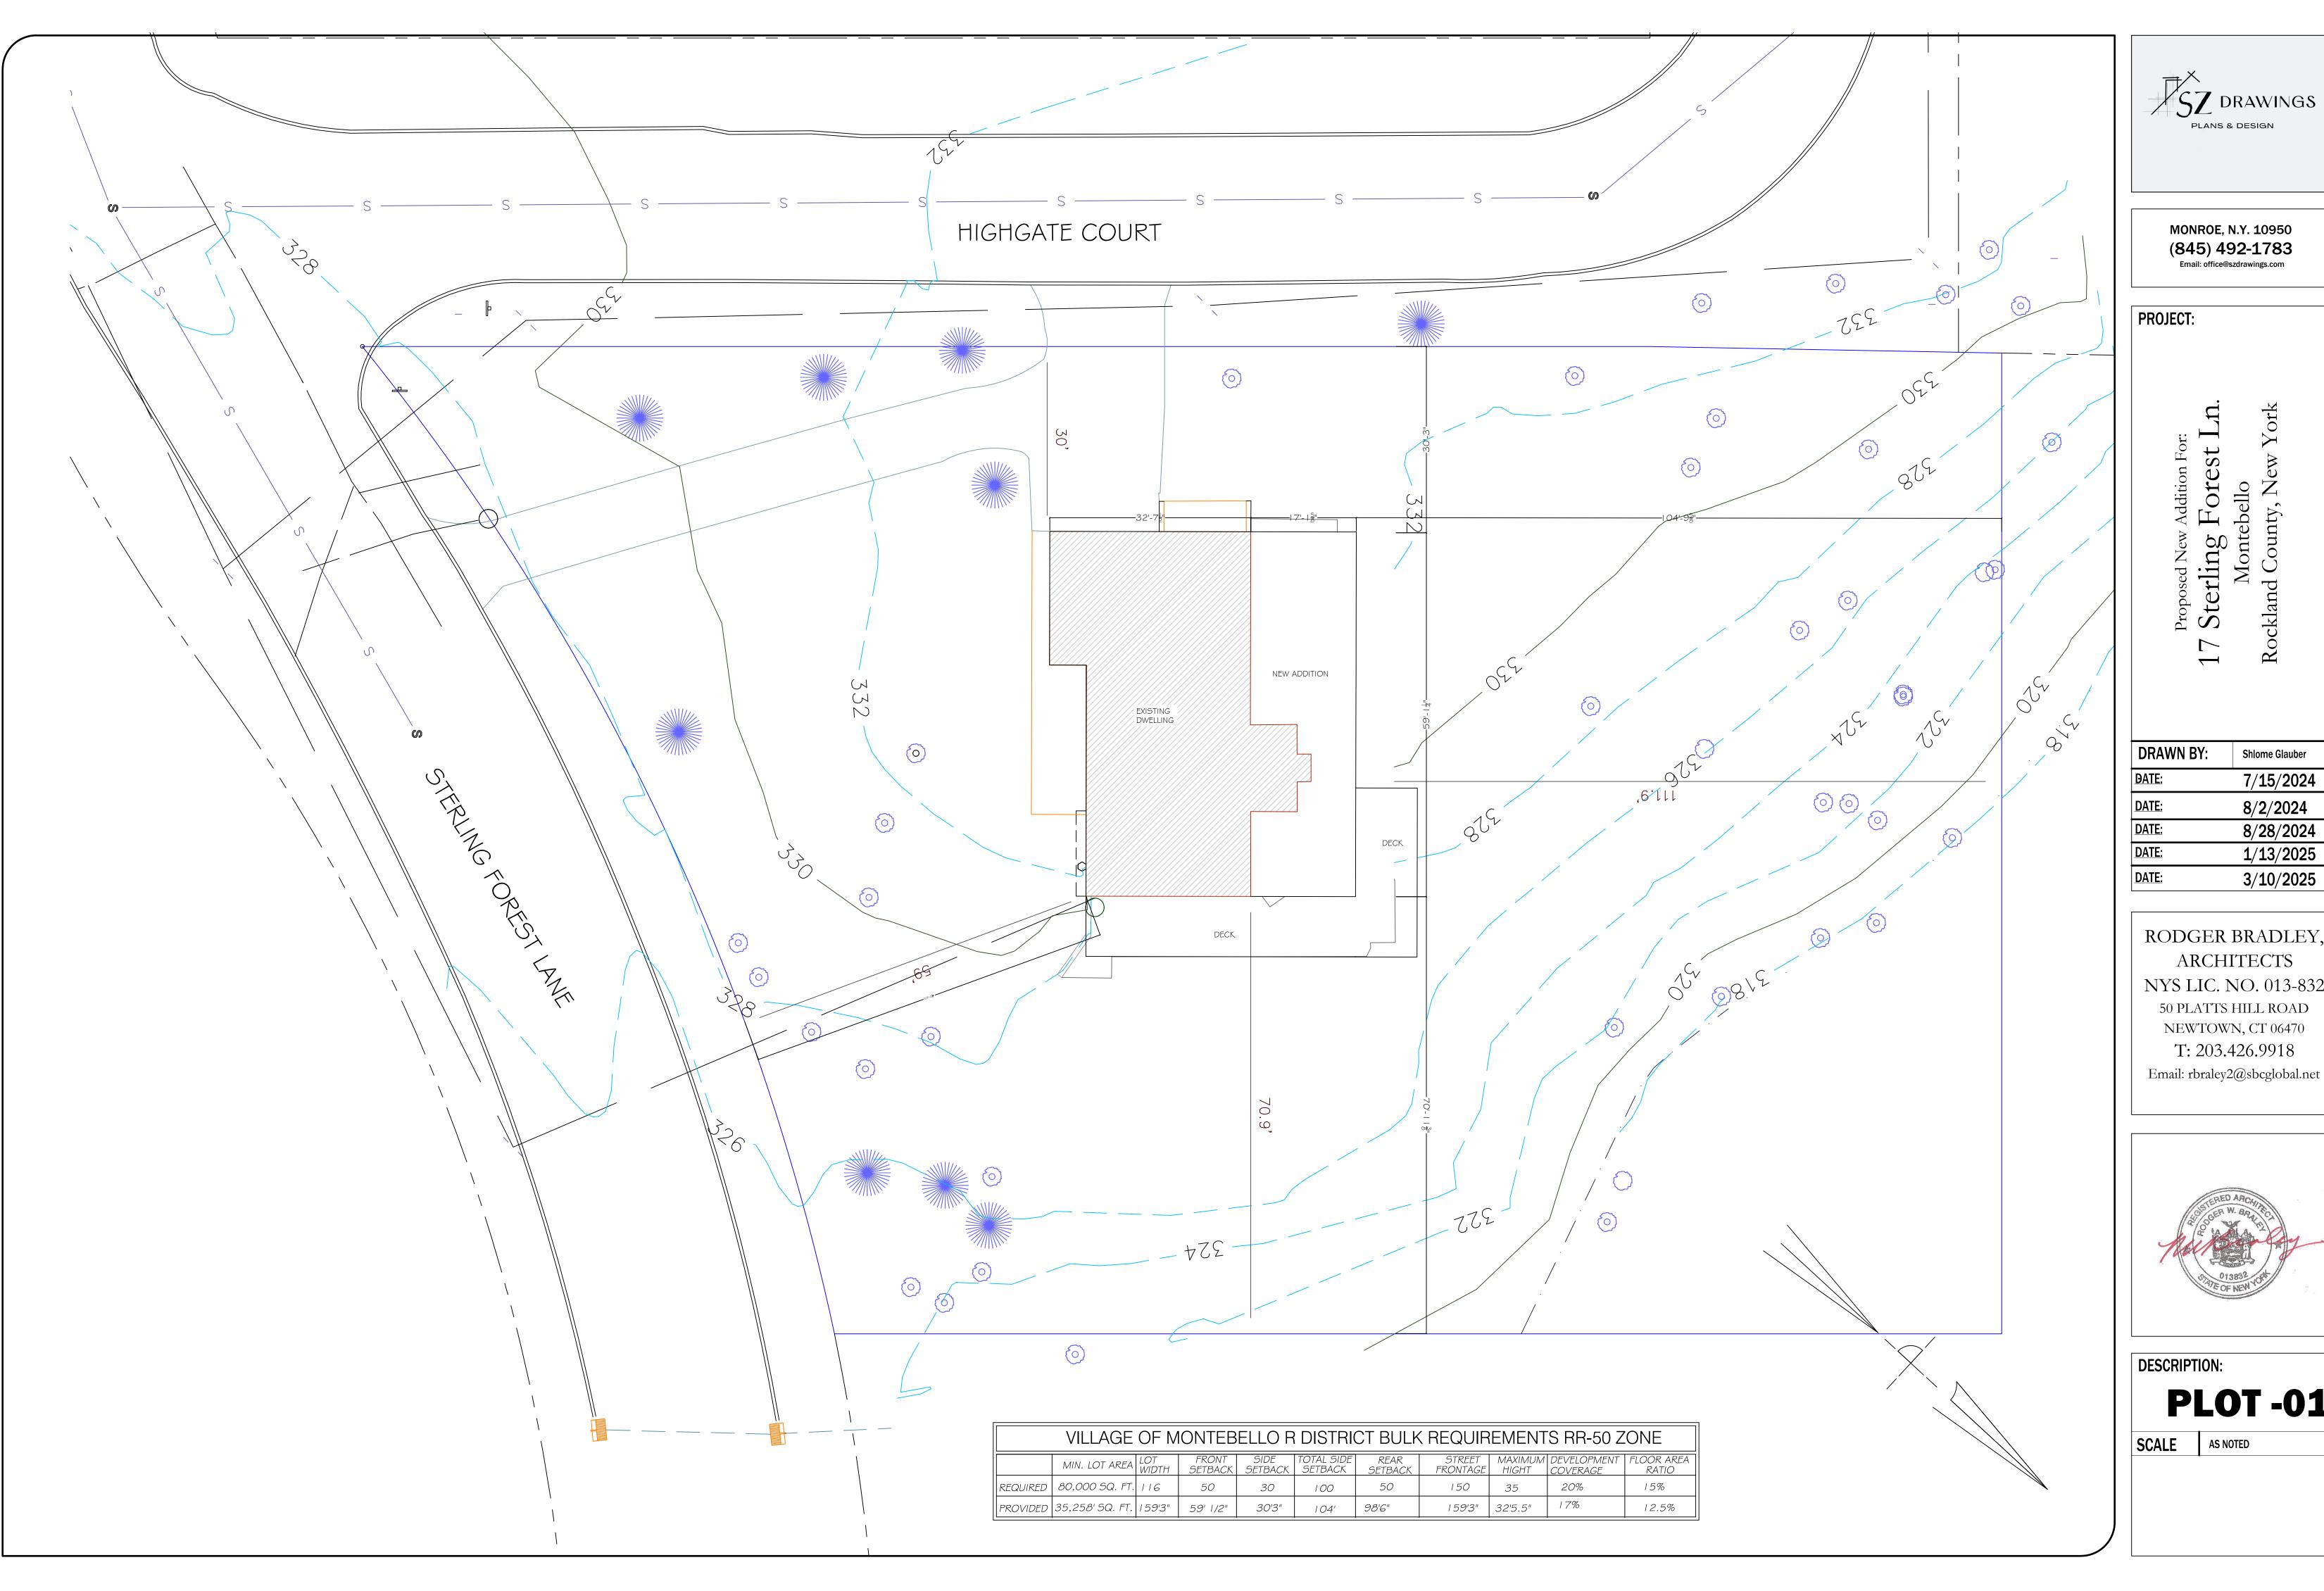




MONROE, N.Y. 10950

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RODGER BRADLEY, ARCHITECTS

NYS LIC. NO. 013-832 50 PLATTS HILL ROAD NEWTOWN, CT 06470 T: 203.426.9918



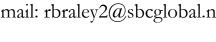

PLOT -01